
TOWN OF NEEDHAM, MASSACHUSETTS DEPARTMENT OF PUBLIC WORKS

NEEDHAM TOWN COMMON RENOVATION

OCTOBER 2021

REV. NOVEMBER, 2021

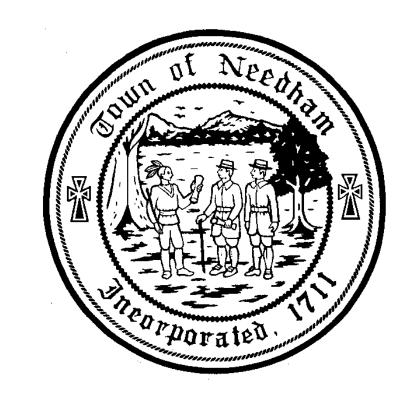

SELECT BOARD

MATTHEW BORRELLI, CHAIRMAN
MARIANNE COOLEY, VICE CHAIRMAN
DANIEL P. MATTHEWS, MEMBER
MARCUS NELSON, MEMBER

TOWN MANAGER


KATHLEEN P. FITZPATRICK

DEPARTMENT OF PUBLIC WORKS

CARYS LUSTIG, DIRECTOR

ROBERT A. LEWIS, ASSISTANT DIRECTOR

EDWARD OLSEN, SUPERINTENDENT PARKS & FORESTRY

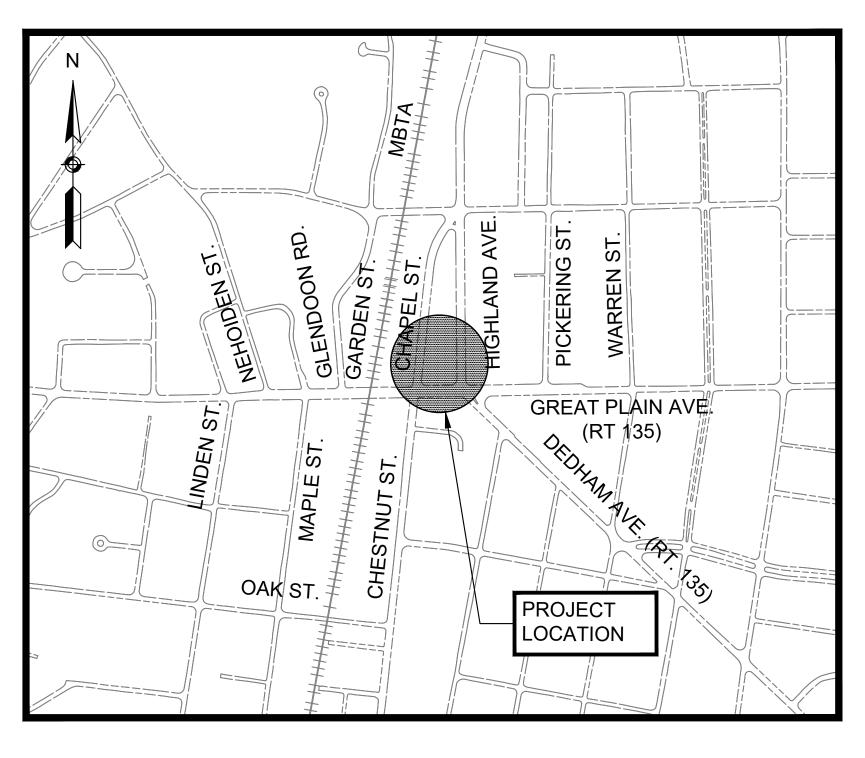

PROJECT LOCATION

LOCATION MAP

1"=500'

PLAN INDEX

SHEET NO.	DESCRIPTION
1	TITLE SHEET & INDEX
2	GENERAL NOTES
3	EXISTING CONDITIONS & SITE PREPARATION PLAN
4	LAYOUT & MATERIALS PLAN
5	GRADING & DRAINAGE PLAN
6	ELECTRICAL PLAN
7	IRRIGATION PLAN
8	IRRIGATION DETAIL
9	PLANTING PLAN
10	DETAILS
11	DETAILS
12	DETAILS
13	ELECTRICAL DETAILS
14	ELECTRICAL DETAILS
15	ELECTRICAL DETAILS
16	ELECTRICAL DETAILS
17	DETAILS
18	DETAILS

PERMIT SET

PREPARED BY:







cott Ridder

der Bob Mackie 11-4-2021

REGISTERED PROFESSIONAL

GENERAL NOTES:

- 1. THE LOCATION OF SUBSURFACE UTILITIES SHOWN IS APPROXIMATE AND NOT GUARANTEED TO BE COMPLETE OR ACCURATE. THE CONTRACTOR SHALL VERIFY THE LOCATIONS AND ELEVATIONS OF EXISTING UTILITY LINES AND STRUCTURES PRIOR TO COMMENCEMENT OF WORK. THE CONTRACTOR MUST NOTIFY DIG SAFE PRIOR TO ANY EXCAVATION, DEMOLITION OR EXPLOSION WORK IN PUBLIC OR PRIVATE WAYS OR UTILITY COMPANY RIGHT-OF-WAY OR EASEMENT.
- 2. WHERE AN EXISTING UTILITY IS FOUND TO CONFLICT WITH THE PROPOSED WORK, THE LOCATION, ELEVATION AND SIZE OF THE UTILITY SHALL BE ACCURATELY DETERMINED WITHOUT DELAY BY THE CONTRACTOR, AND THE INFORMATION FURNISHED TO THE ENGINEER FOR THE RESOLUTION OF THE CONFLICT.
- 3. THE CONTRACTOR SHALL ALTER THE MASONRY OF THE TOP SECTION OF ALL EXISTING DRAINAGE AND SANITARY STRUCTURES AS NECESSARY FOR THE CHANGES IN GRADE, AND RESET ALL WATER AND DRAINAGE FRAMES, GRATES AND BOXES TO THE PROPOSED FINISH SURFACE GRADE. REQUIRED NEW MASONRY SHALL BE CLAY BRICK CONFORMING TO M4.05.2.
- 4. THE CONTRACTOR SHALL MAKE ALL ARRANGEMENTS FOR THE ALTERATION AND ADJUSTMENT OF GAS, ELECTRIC, TELEPHONE, CABLE TV, FIRE ALARM AND ANY OTHER PRIVATE UTILITIES BY THE UTILITY COMPANIES. ALL UTILITY CASTING AND FIRE ALARM BOXES SHALL BE ADJUSTED TO FINISH GRADE BY THEIR RESPECTIVE OWNERS.
- 5. AREAS OUTSIDE THE LIMITS OF PROPOSED WORK DISTURBED BY THE CONTRACTOR'S OPERATIONS SHALL BE RESTORED BY THE CONTRACTOR TO THEIR ORIGINAL CONDITION AT THE CONTRACTOR'S EXPENSE.
- 6. THE TERM "PROPOSED" (PROP.) MEANS WORK TO BE CONSTRUCTED USING NEW MATERIALS OR, WHERE APPLICABLE, RE-USING EXISTING MATERIALS IDENTIFIED AS "REMOVE AND RESET" (R&R).
- 7. ALL DRAINAGE STRUCTURES SHALL BE RETAINED UNLESS NOTED OTHERWISE.
- 8. ALL FRAMES AND GRATES FOR PROPOSED DRAINAGE STRUCTURES SHALL BE MUNICIPAL STANDARD.
- 9. UNLESS OTHERWISE NOTED EXISTING DRAINAGE LINES TO BE REPLACED SHALL BE ABANDONED IN PLACE. IF THEY CONFLICT WITH THE PROPOSED DRAINAGE LINES THEY SHALL BE REMOVED AS DIRECTED BY THE ENGINEER.
- 10. WHERE DRAINAGE PIPES OR STRUCTURES ARE ABANDONED IN PLACE THE CONTRACTOR SHALL MAKE SURE THAT ALL CONNECTING PIPES, INLETS AND OUTLETS ARE PLUGGED. ALL LIVE CONNECTIONS SHALL BE CONNECTED TO THE NEW SYSTEM.
- 11. ALL CURB TIE DIMENSIONS ARE TO THE FACE OF THE CURB.
- 12. PROPOSED SIDEWALKS AND WHEELCHAIR RAMPS SHALL BE CONSTRUCTED TO THE NEAREST SCORE LINE OR EXPANSION JOINT IN THE EXISTING ADJACENT WALK SURFACE AS DIRECTED BY THE ENGINEER.
- 13. PROPOSED SIDEWALK AT SIGNS, POLES AND OTHER FEATURES SHALL BE BOXED AND PROVIDED FLEXIBLE JOINT FILLER.
- 14. THE PROPOSED SIDEWALK GRADE SHALL MEET THE EXISTING GRADE AT ALL ADJOINING PAVEMENT ELEVATIONS UNLESS OTHERWISE NOTED ON THE PLAN.
- 15. PROPOSED SIDEWALK AND WHEELCHAIR RAMPS SCORE LINES AND EXPANSION JOINTS ARE SHOWN ON THE PLANS. THE CONTRACTOR SHALL COORDINATE WITH THE ENGINEER DURING CONSTRUCTION.
- 16. WHEN WORKING NEXT TO EXISTING PAVEMENT, WALLS, BERMS, AND OTHER STRUCTURES, CONTRACTOR SHALL EXERCISE EXTREME CAUTION NOT TO DISTURB THE EXISTING STRUCTURES. ANY DAMAGE TO THE EXISTING STRUCTURES SHALL BE REPAIRED BY THE CONTRACTOR AT HIS OWN EXPENSE.
- 17. ORNAMENTAL STREET LIGHTING LAYOUTS ARE SHOWN ON ELECTRICAL PLANS. THE DETAILS ARE SHOWN ON DETAIL SHEETS.
- 18. DUE TO THE PROJECT IN DOWNTOWN AREA, CONTRACTOR SHALL EXERCISE EXTREME CAUTION NOT TO DISTURB EXISTING SIDEWALK. THE CONTRACTOR SHALL MEET ALL EXISTING GRADES AT THESE LOCATIONS UNLESS OTHERWISE SHOWN ON THE PLAN.
- 19. SAFETY CONTROLS FOR CONSTRUCTION OPERATIONS SHALL BE IN ACCORDANCE WITH MASSDOT REQUIREMENTS AND THE LATEST VERSION OF THE MUTCD.
- 20. SURVEY BASE PLAN BY CHAPPELL ENGINEERING ASSOCIATES, LLC ON OCTOBER 2018.
- 21. THE SURVEY BASE PLAN ARE IN U.S. SURVEY FEET IN THE MASSACHUSETTS STATE PLANE COORDINATE SYSTEM REFERENCED TO THE NORTH AMERICAN DATUM OF 1983.
- 22. ELEVATIONS, IN U.S. SURVEY FEET, ARE REFERENCED TO THE NORTH AMERICAN VERTICAL DATUM OF 1988 (NAVD88).
- 23. PROPOSED TREE LOCATIONS ARE APPROXIMATE. THE CONTRACTOR SHALL STAKE TREES IN THE FIELD PRIOR TO INSTALLATION FOR APPROVAL BY THE ENGINEER.
- 24. LOCATION OF PROPOSED SHRUB PLANTINGS ARE APPROXIMATE. THE CONTRACTOR SHALL COORDINATE WITH THE ENGINEER PRIOR TO INSTALLATION.
- 25. THE CONTRACTOR SHALL BE REQUIRED TO MAINTAIN A MINIMUM LEVEL OF GENERAL STREET LIGHTING EQUIVANENT TO THE EXISTING CONDITION OVER THE COURSE OF THE PROJECT EITHER BY TEMPORARILY RETAINING SOME OF THE EXISTING LIGHTS AND/OR ACTIVATING PORTIONS OF THE NEW LIGHTING SYSTEMS. THE CONTRACTOR SHALL BE REQUIRED TO IDENTIFY HIS APPROACH IN HIS POST BID SCHEDULE.

WHEELCHAIR RAMP NOTES:

- 1. ALL WHEELCHAIR RAMPS SHALL CONFORM TO THE REQUIREMENTS OF THE ARCHITECTURAL ACCESS BOARD (A.A.B.) AND THE AMERICANS WITH DISABILITIES ACT (A.D.A.). AND THE TOWN OF NEEDHAM STANDARDS.
- 2. THE LOCATION OF PROPOSED WHEELCHAIR RAMP ARE SHOWN ON LAYOUT PLAN AND THE DETAILS, EXACT LOCATION MAY BE ADJUSTED, IF NECESSARY, BY THE ENGINEER IN THE FIELD.
- 3. PROPOSED WHEELCHAIR RAMPS SHALL HAVE DETECTABLE WARNING PANELS INSTALLED IN ACCORDANCE WITH AAB AND ADA STANDARDS. THE PANEL SHALL BE VARIED TO MEET OPENINGS OF THE RAMP AS SHOWN. THE PANEL SHALL BE GRANITE AND COLORED CALEDONIA.
- 4. IN INSTANCES WHERE AN EXISTING MANHOLE, HANDHOLE OR OTHER "SURFACE" TYPE STRUCTURE THAT CANNOT BE REMOVED OR RESET, IS WITHIN THE ACTUAL WHEELCHAIR RAMP PATH, THE STRUCTURE SHALL BE CAREFULLY ADJUSTED SUCH THAT THE TOPMOST SURFACES OF THE STRUCTURE COVER SHALL BE FLUSH WITH THE RAMP SURFACE AND SHALL MATCH THE SLOPE OF THE NEW WHEELCHAIR RAMP AS DIRECTED BY THE ENGINEER.

PAVEMENT NOTES:

PAVEMENT MILLING AND OVERLAY

SURFACE COURSE: 1 ½" CLASS I BITUMINOUS CONCRETE TOP COURSE

PAVEMENT MILLING: 1 ½" PAVEMENT MILLING

NOTE: 1.5" MAX LIFT BINDER COURSE FOR LEVELING IN AREAS NOT ABLE TO BE SHAPED WITH MILLING.

CONCRETE SIDEWALK, WHEELCHAIR RAMPS, AND DRIVEWAYS

SURFACE COURSE: 5" CEMENT CONCRETE

SUB BASE: 8" GRAVEL BORROW TYPE C (MIN.) OR

COMBINATION OF EXISTING SUITABLE SUB BASE AS

APPROVED BY THE ENGINEER.

HMA SIDEWALK

SURFACE COURSE: 3" HOT MIX ASPHALT (HMA) PAVEMENT PLACED IN TWO LAYERS, 1" TOP


COURSE MATERIAL OVER 2" BINDER COURSE MATERIAL

BASE COURSE: 8" GRAVEL BORROW TYPE C (MIN.)

INSIDE COMMON AREA

COMMON AREA	Existing	Area %	PROPOSED	Area %
Paths and Walkways	4,121 s.f.	14.5 %	8,239 s.f.	28.8 %
Planted Areas	617 s.f.	2.1 %	1586 s.f.	5.5 %
Lawn Area	23,844 s.f.	83.4 %	18,767 s.f.	65.7 %
TOTAL	28.592 s.f.	100.0 %	28.592 s.f.	100.0 %


ENTIRE LOT						
LOT AREA %	EXISTING					
Building	16.54%					
Paved Areas	34.0%					
Open Space	49.46%					

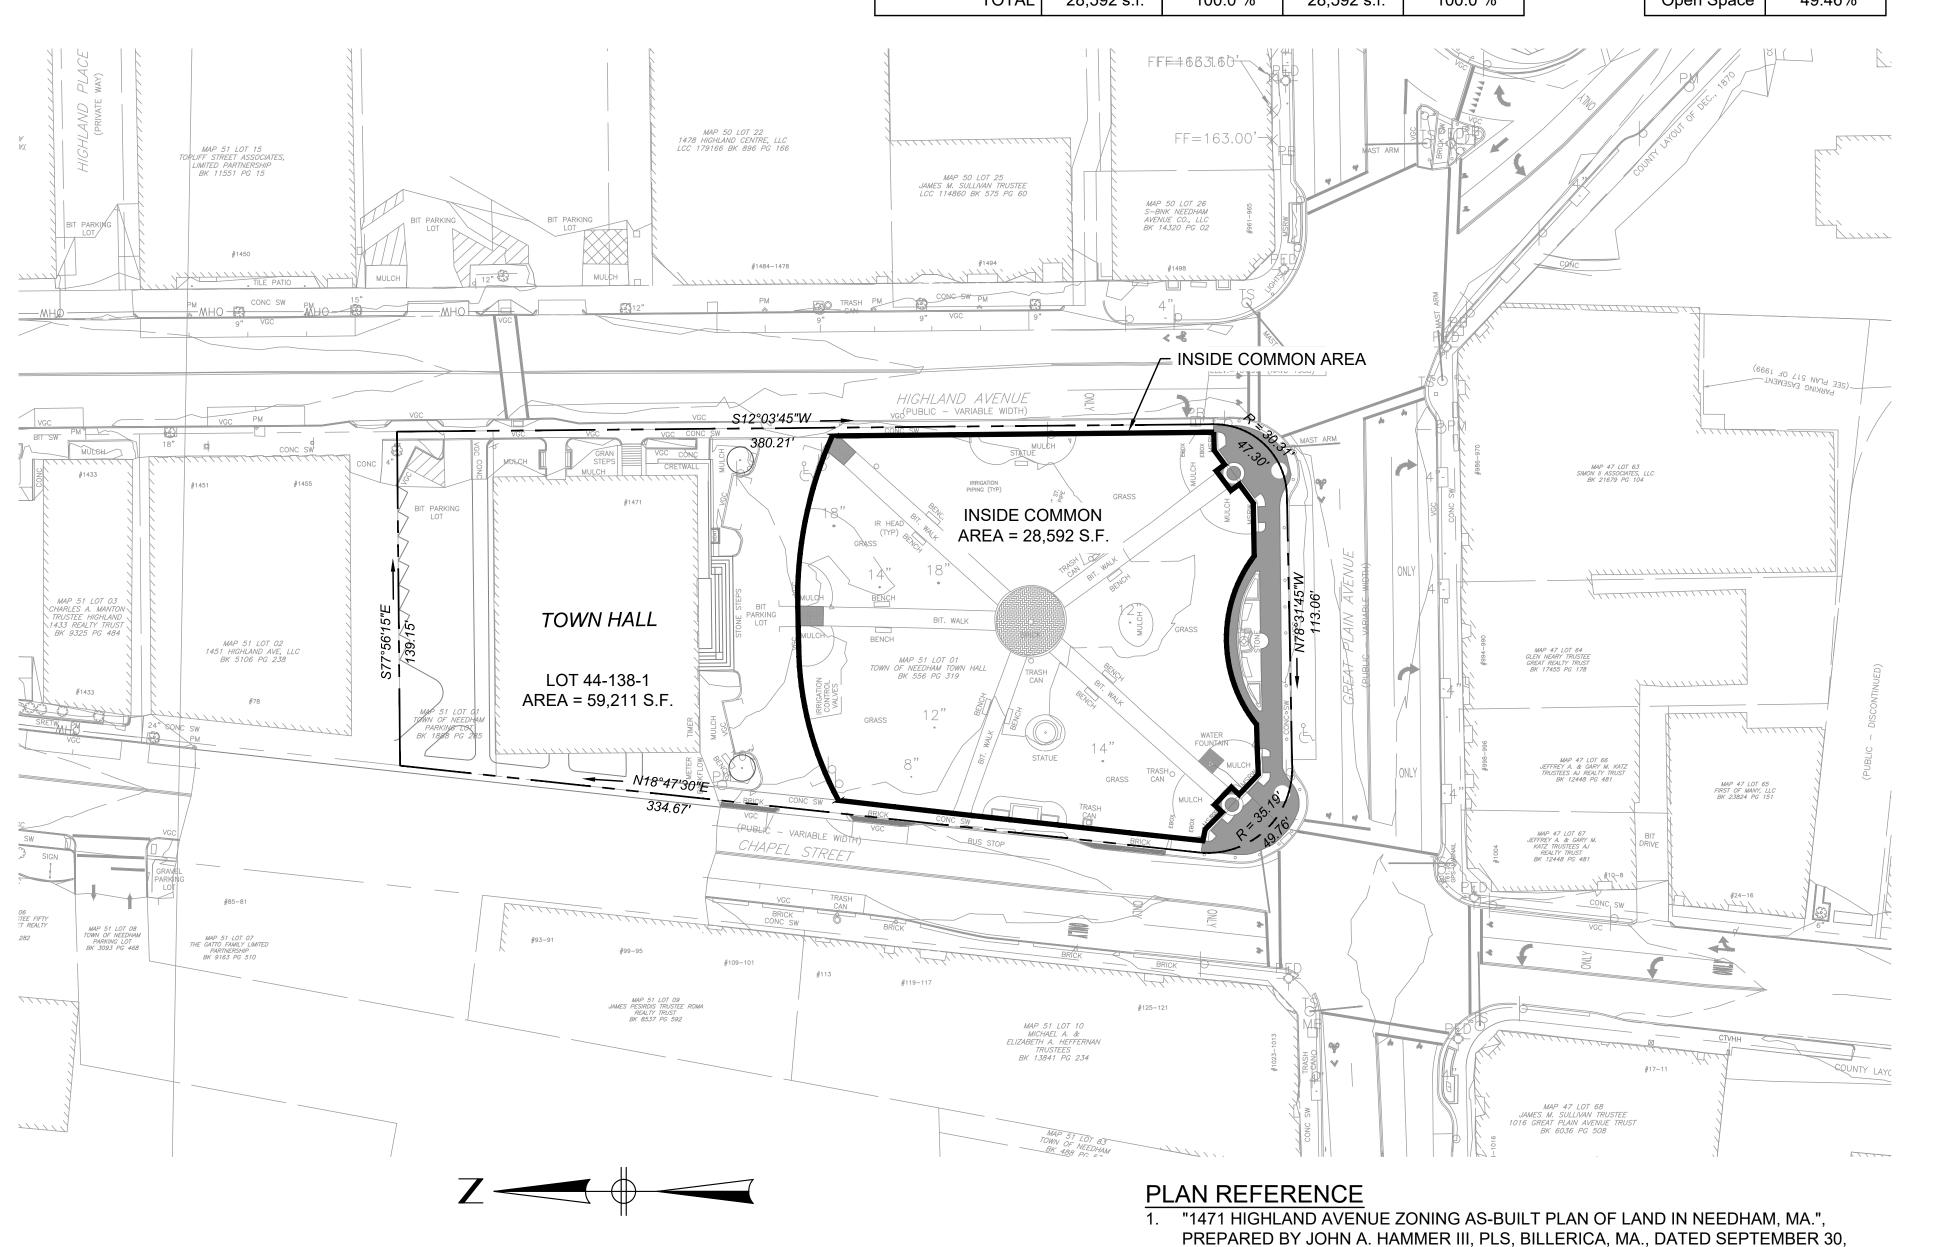



PROPERTY INFORMATION
SCALE: 1" = 40'


2011, SHEETS 1 AND 2. NOTED AS BUILDING PERMIT No. B120100159.


DRAWN BY: REGISTERED PROFESSIONAL PREPARED BY SUBCONSULTANT CALE TITLE _ 7185 BETA JOB NO. TOWN COMMON RENOVATION SR/NS/CC NOV. 4, 2021 ISSUE DATE . DESIGNED BY **AS SHOWN GENERAL NOTES** www.BETA-Inc.com CHECKED BY: SHEET NO. NEEDHAM, MASSACHUSETTS SR/RM DATE MADE BY CHECKED BY **REVISIONS** ESS OTHERWISE NOTED OR CHANGED BY REPRODUCTION

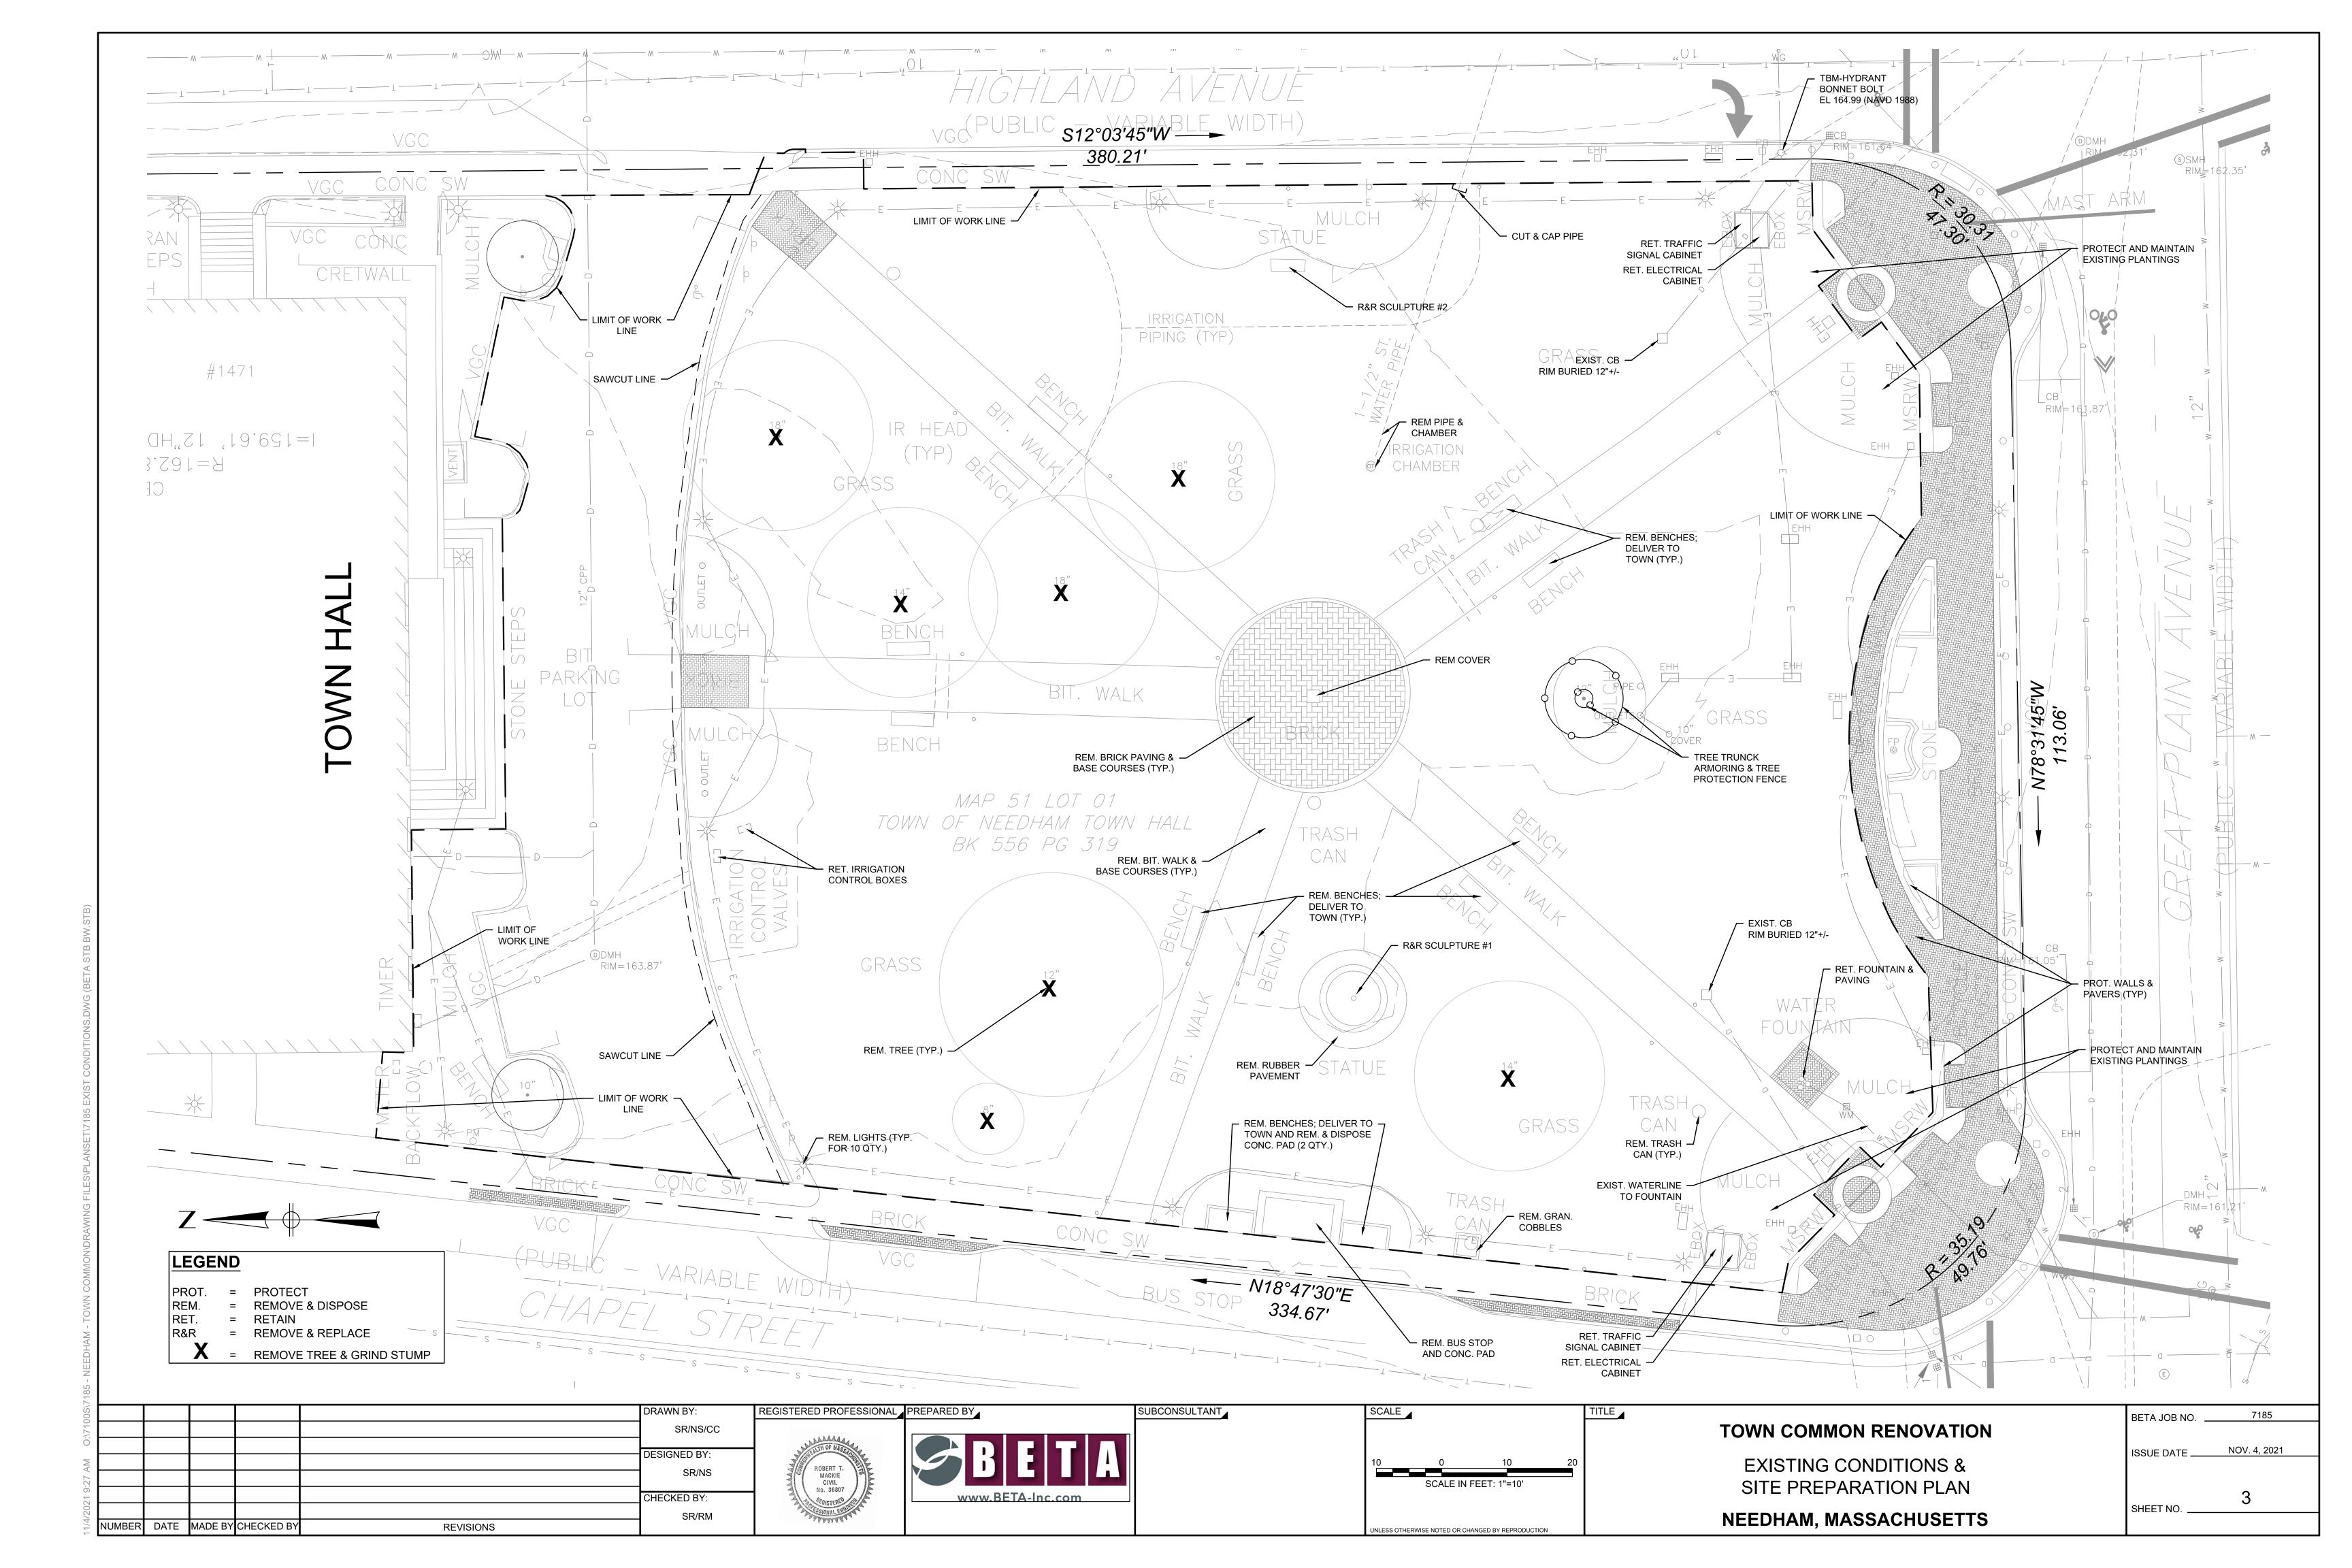


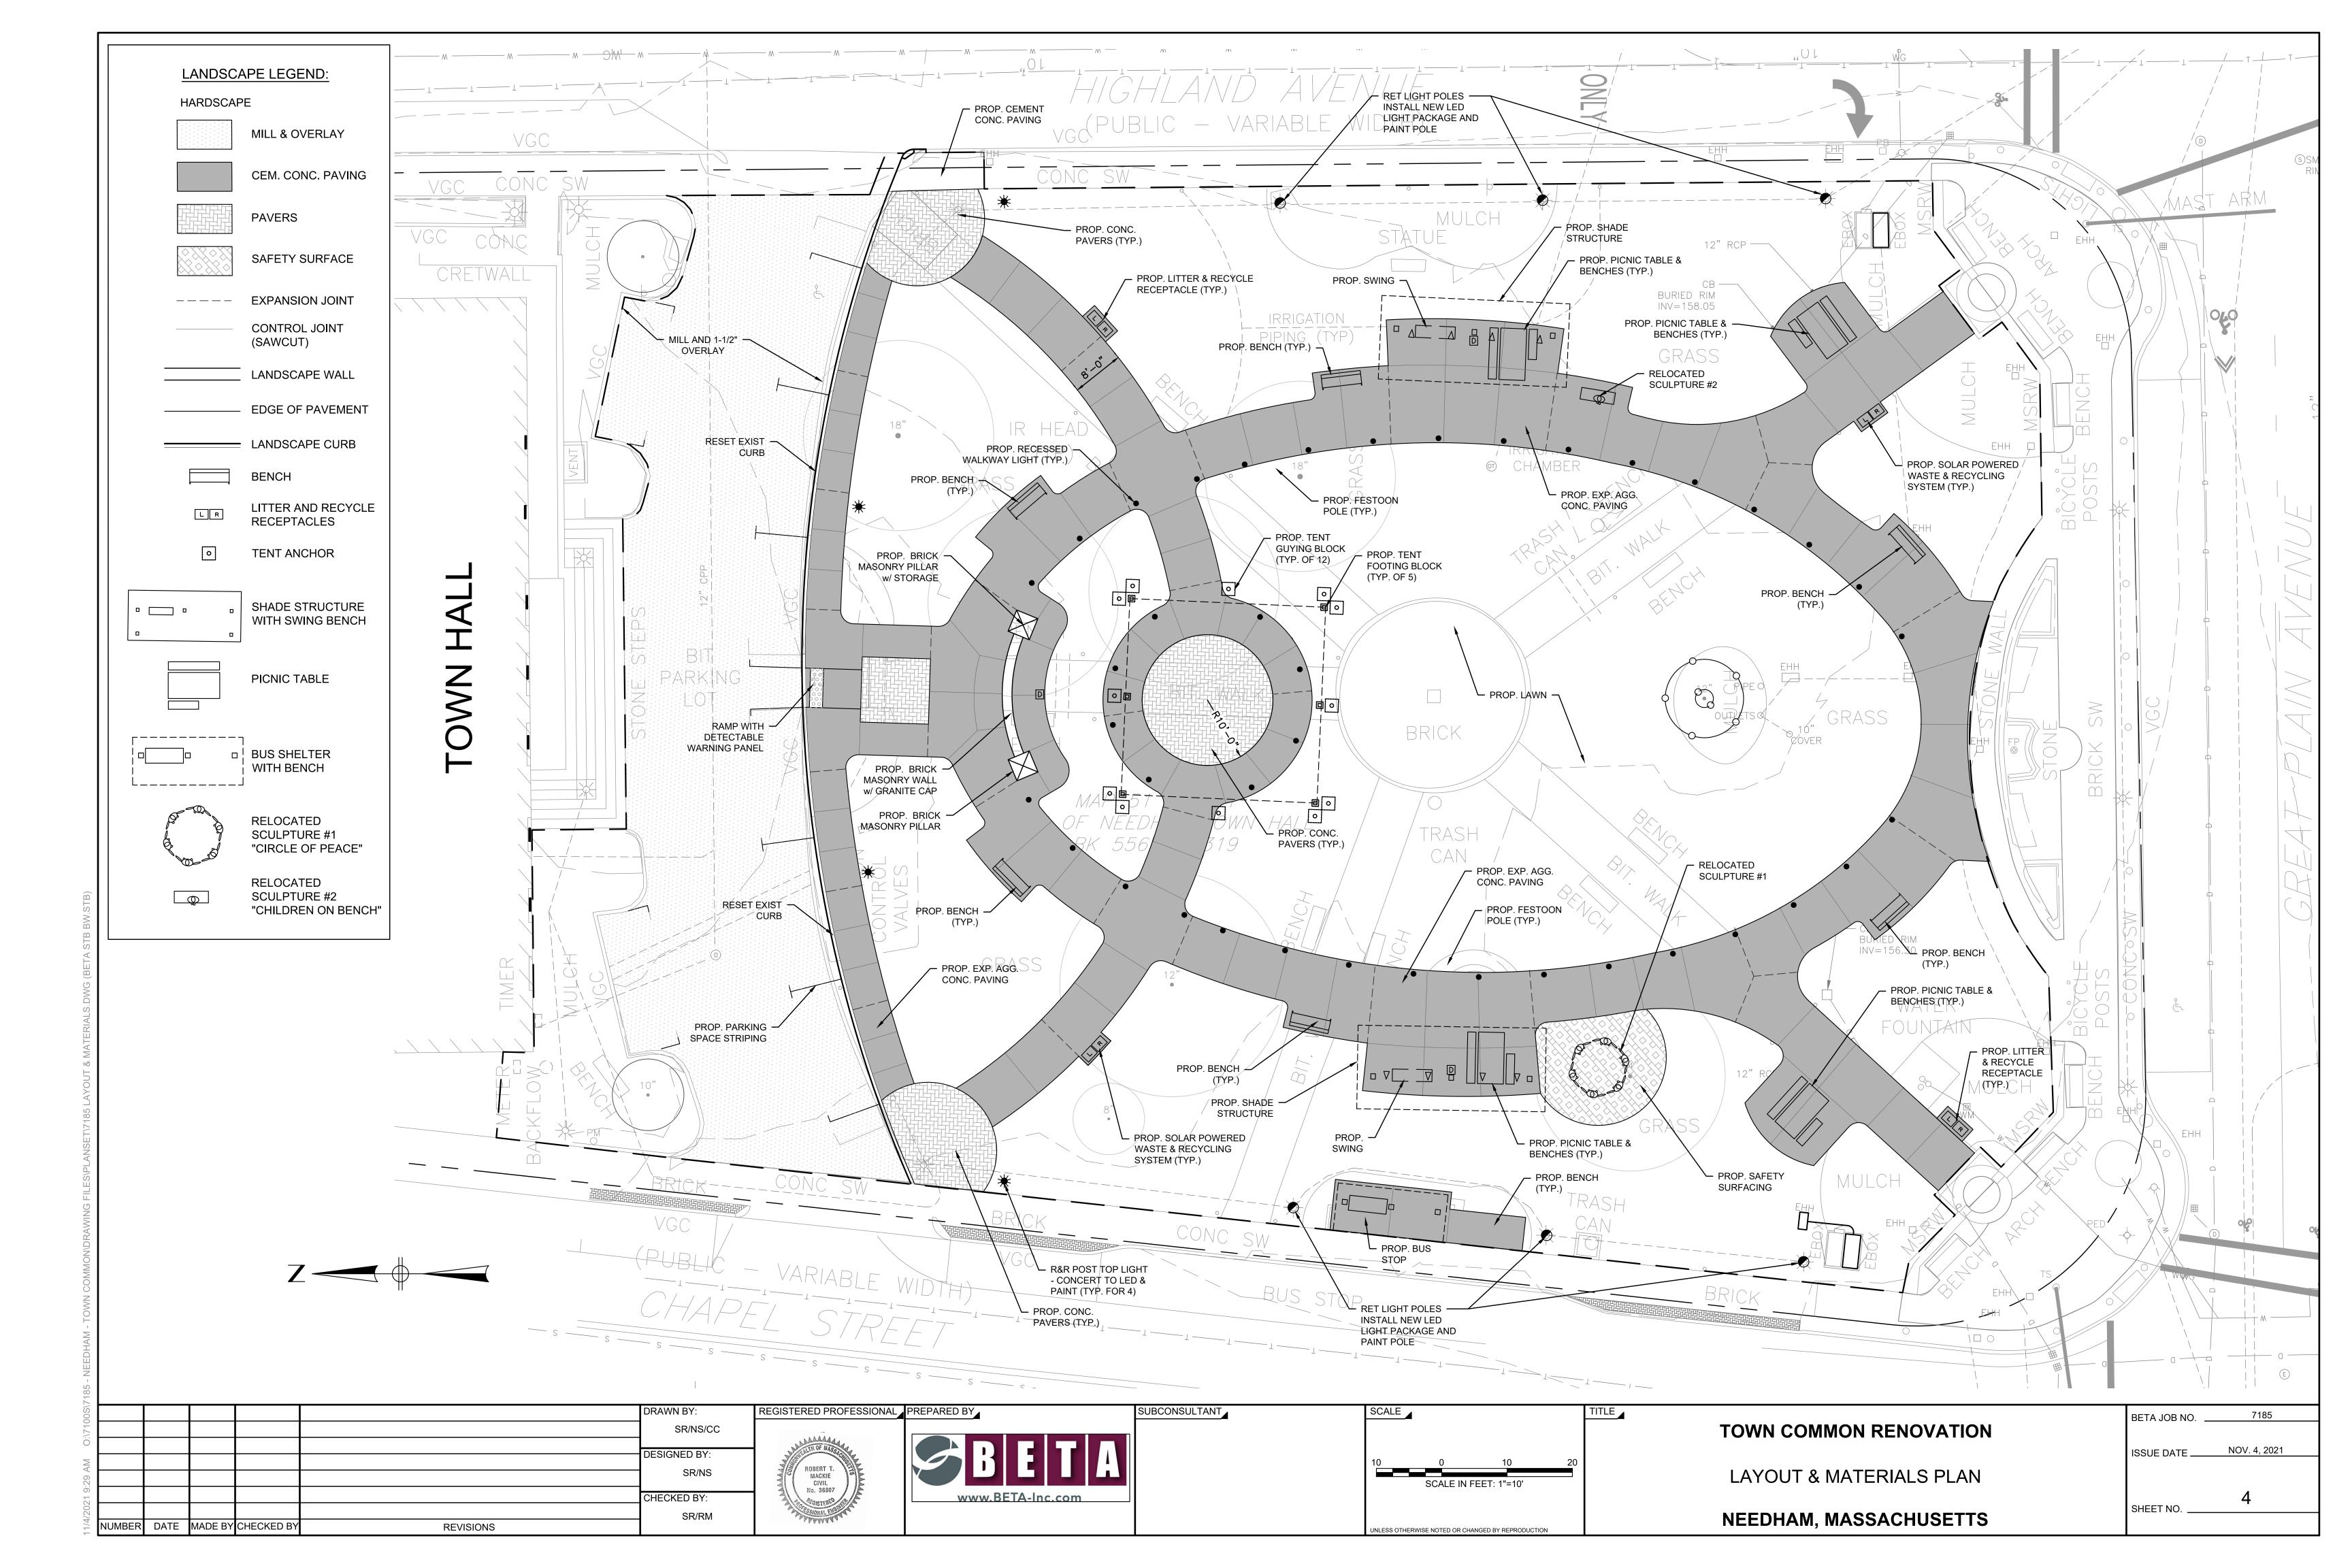


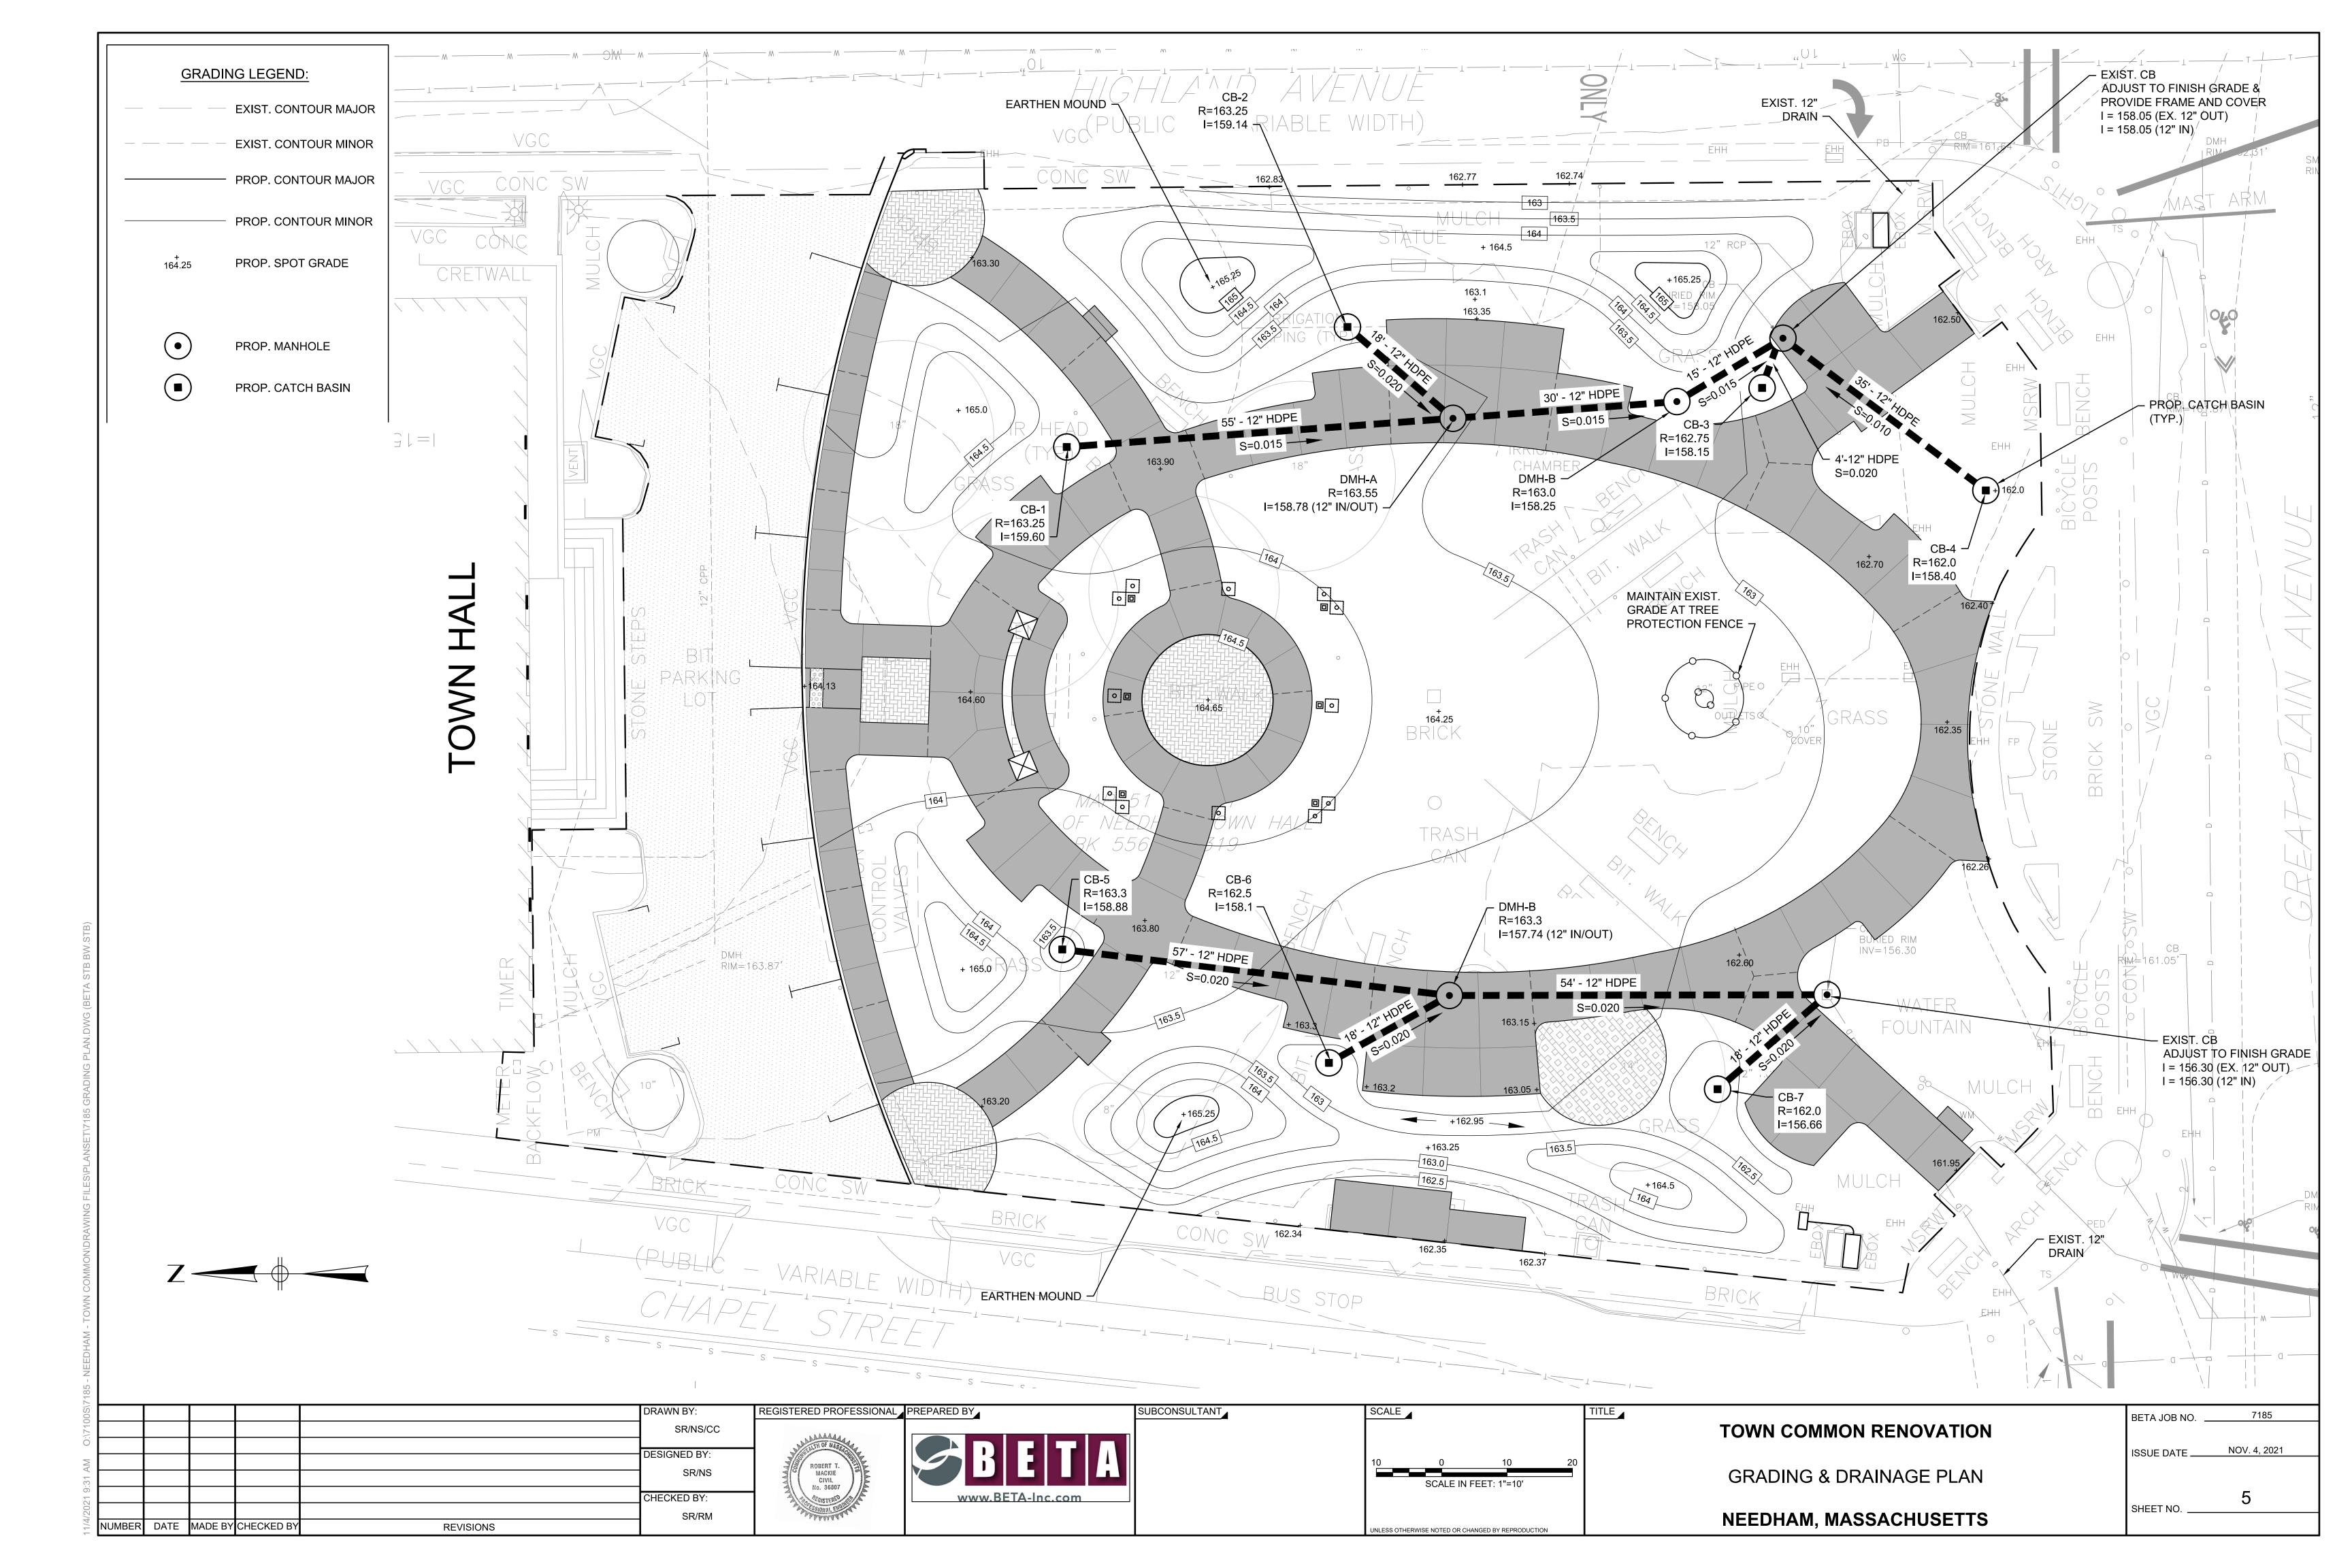


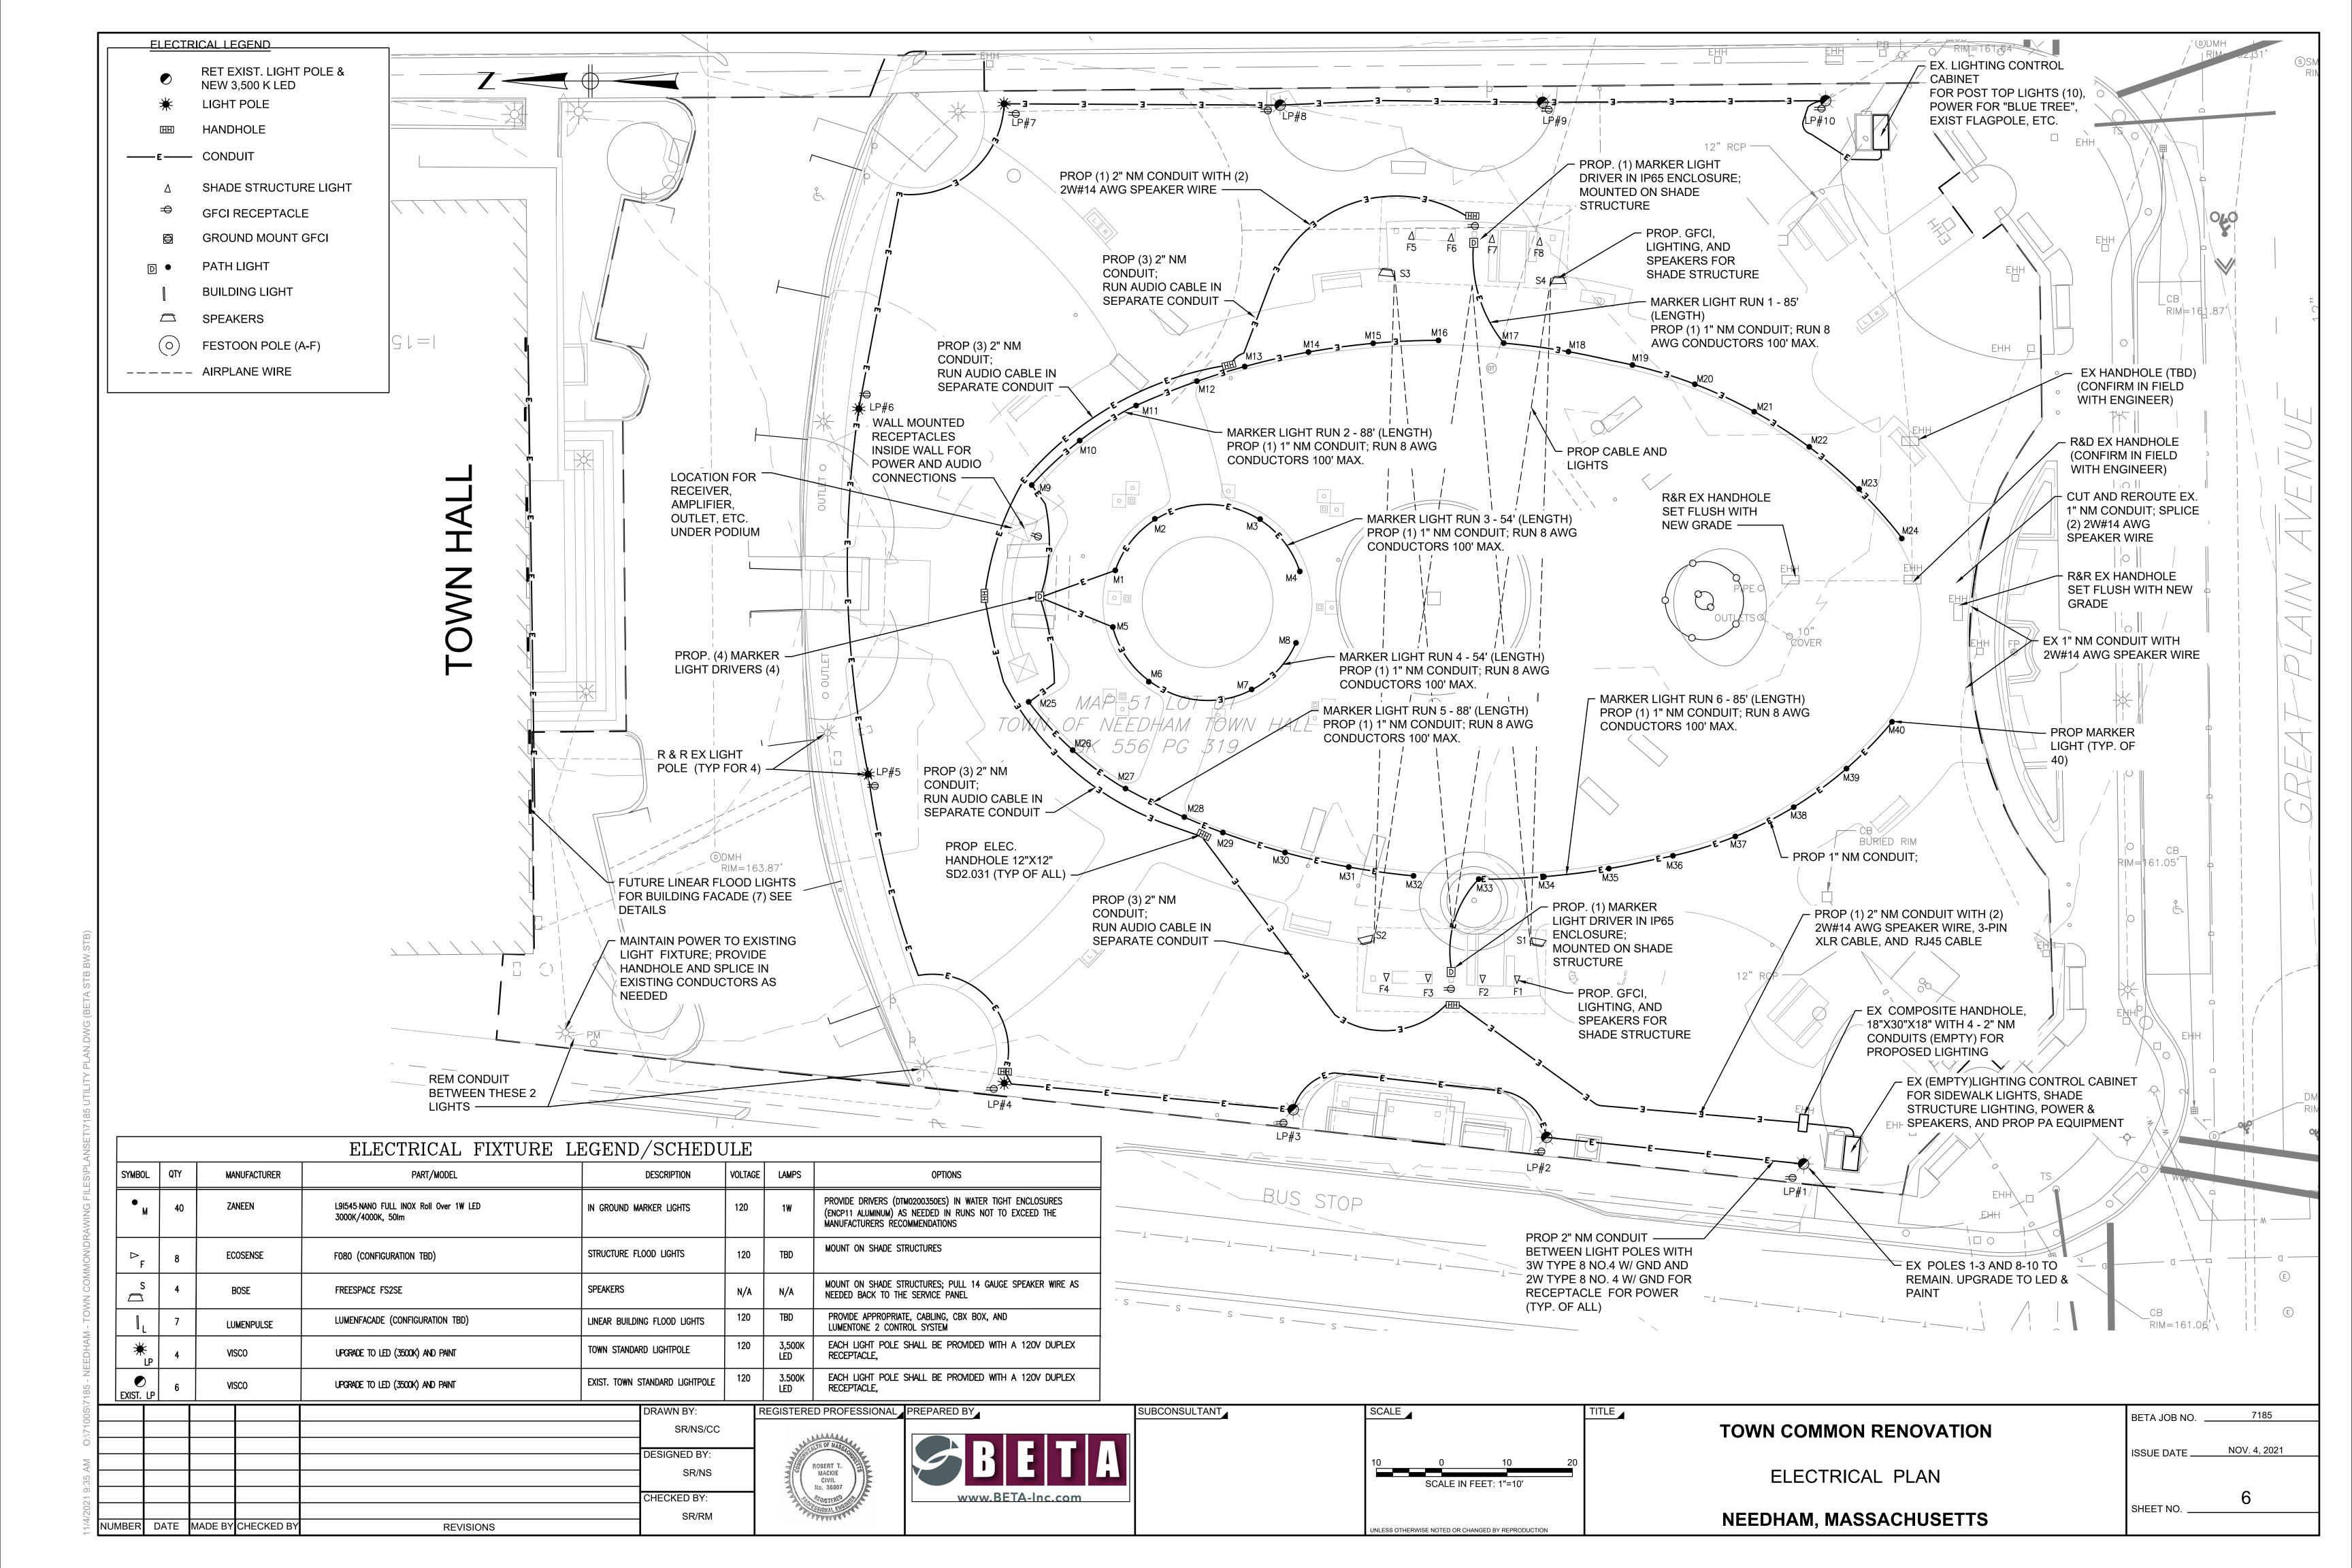

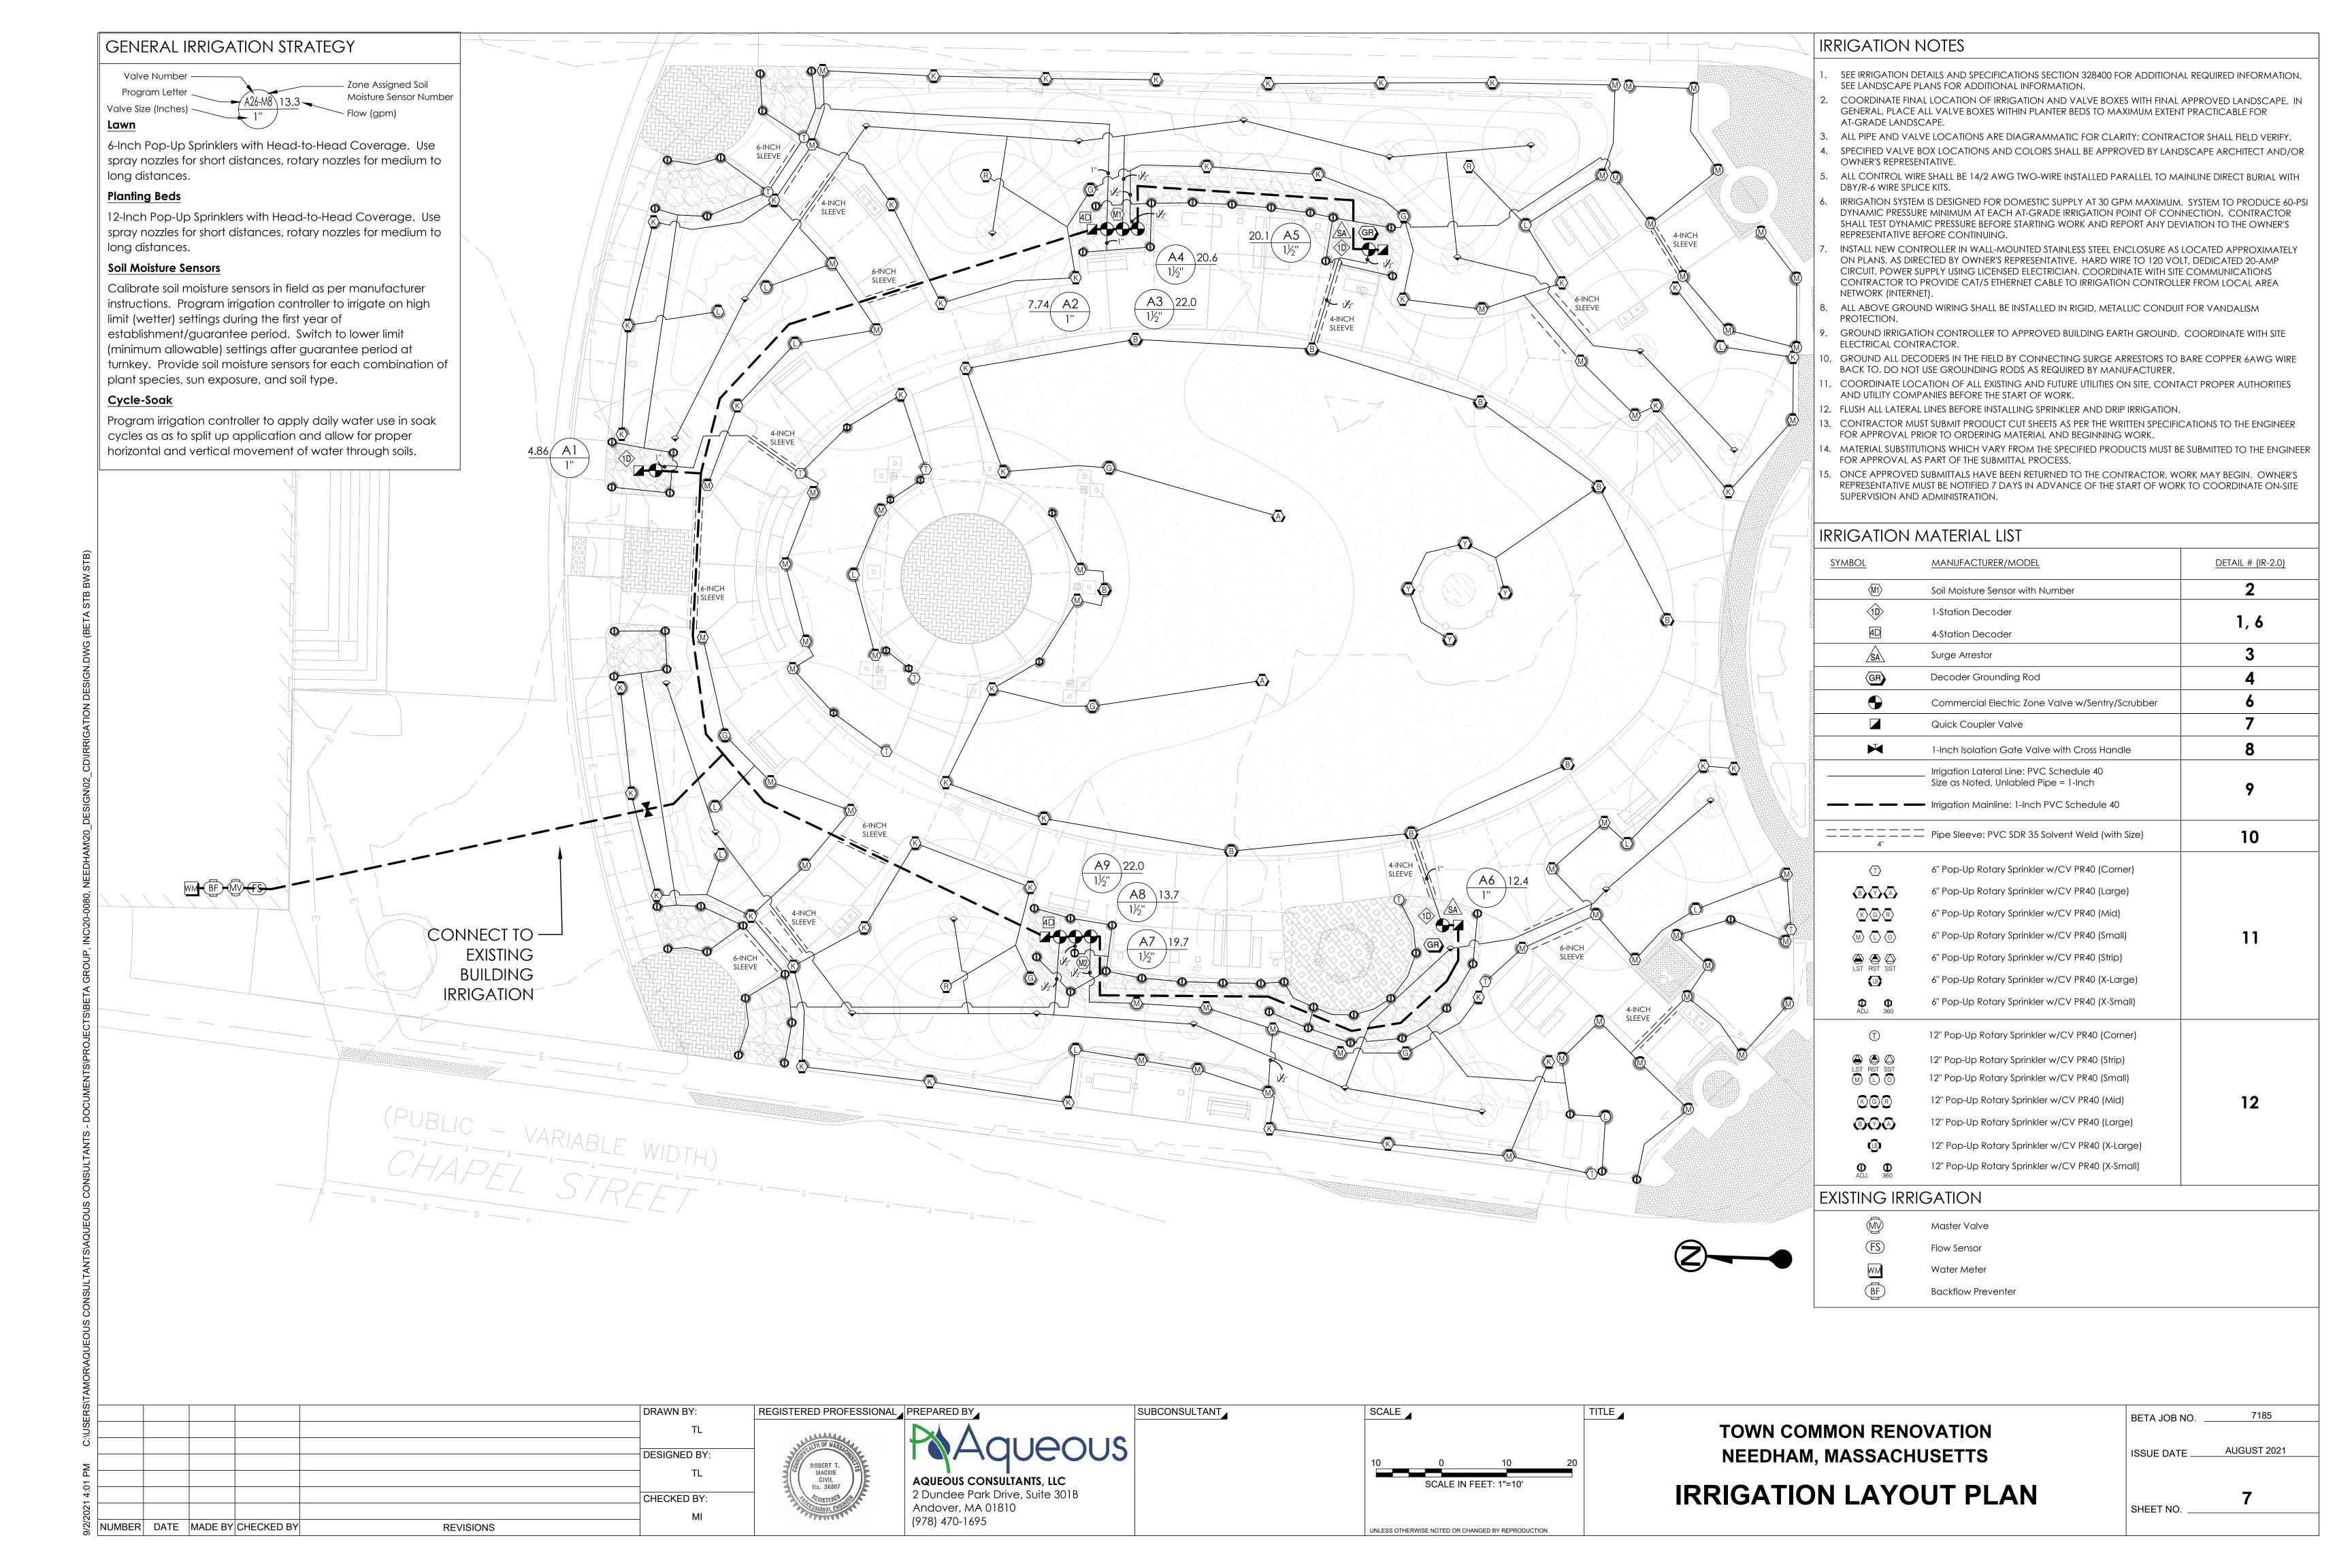

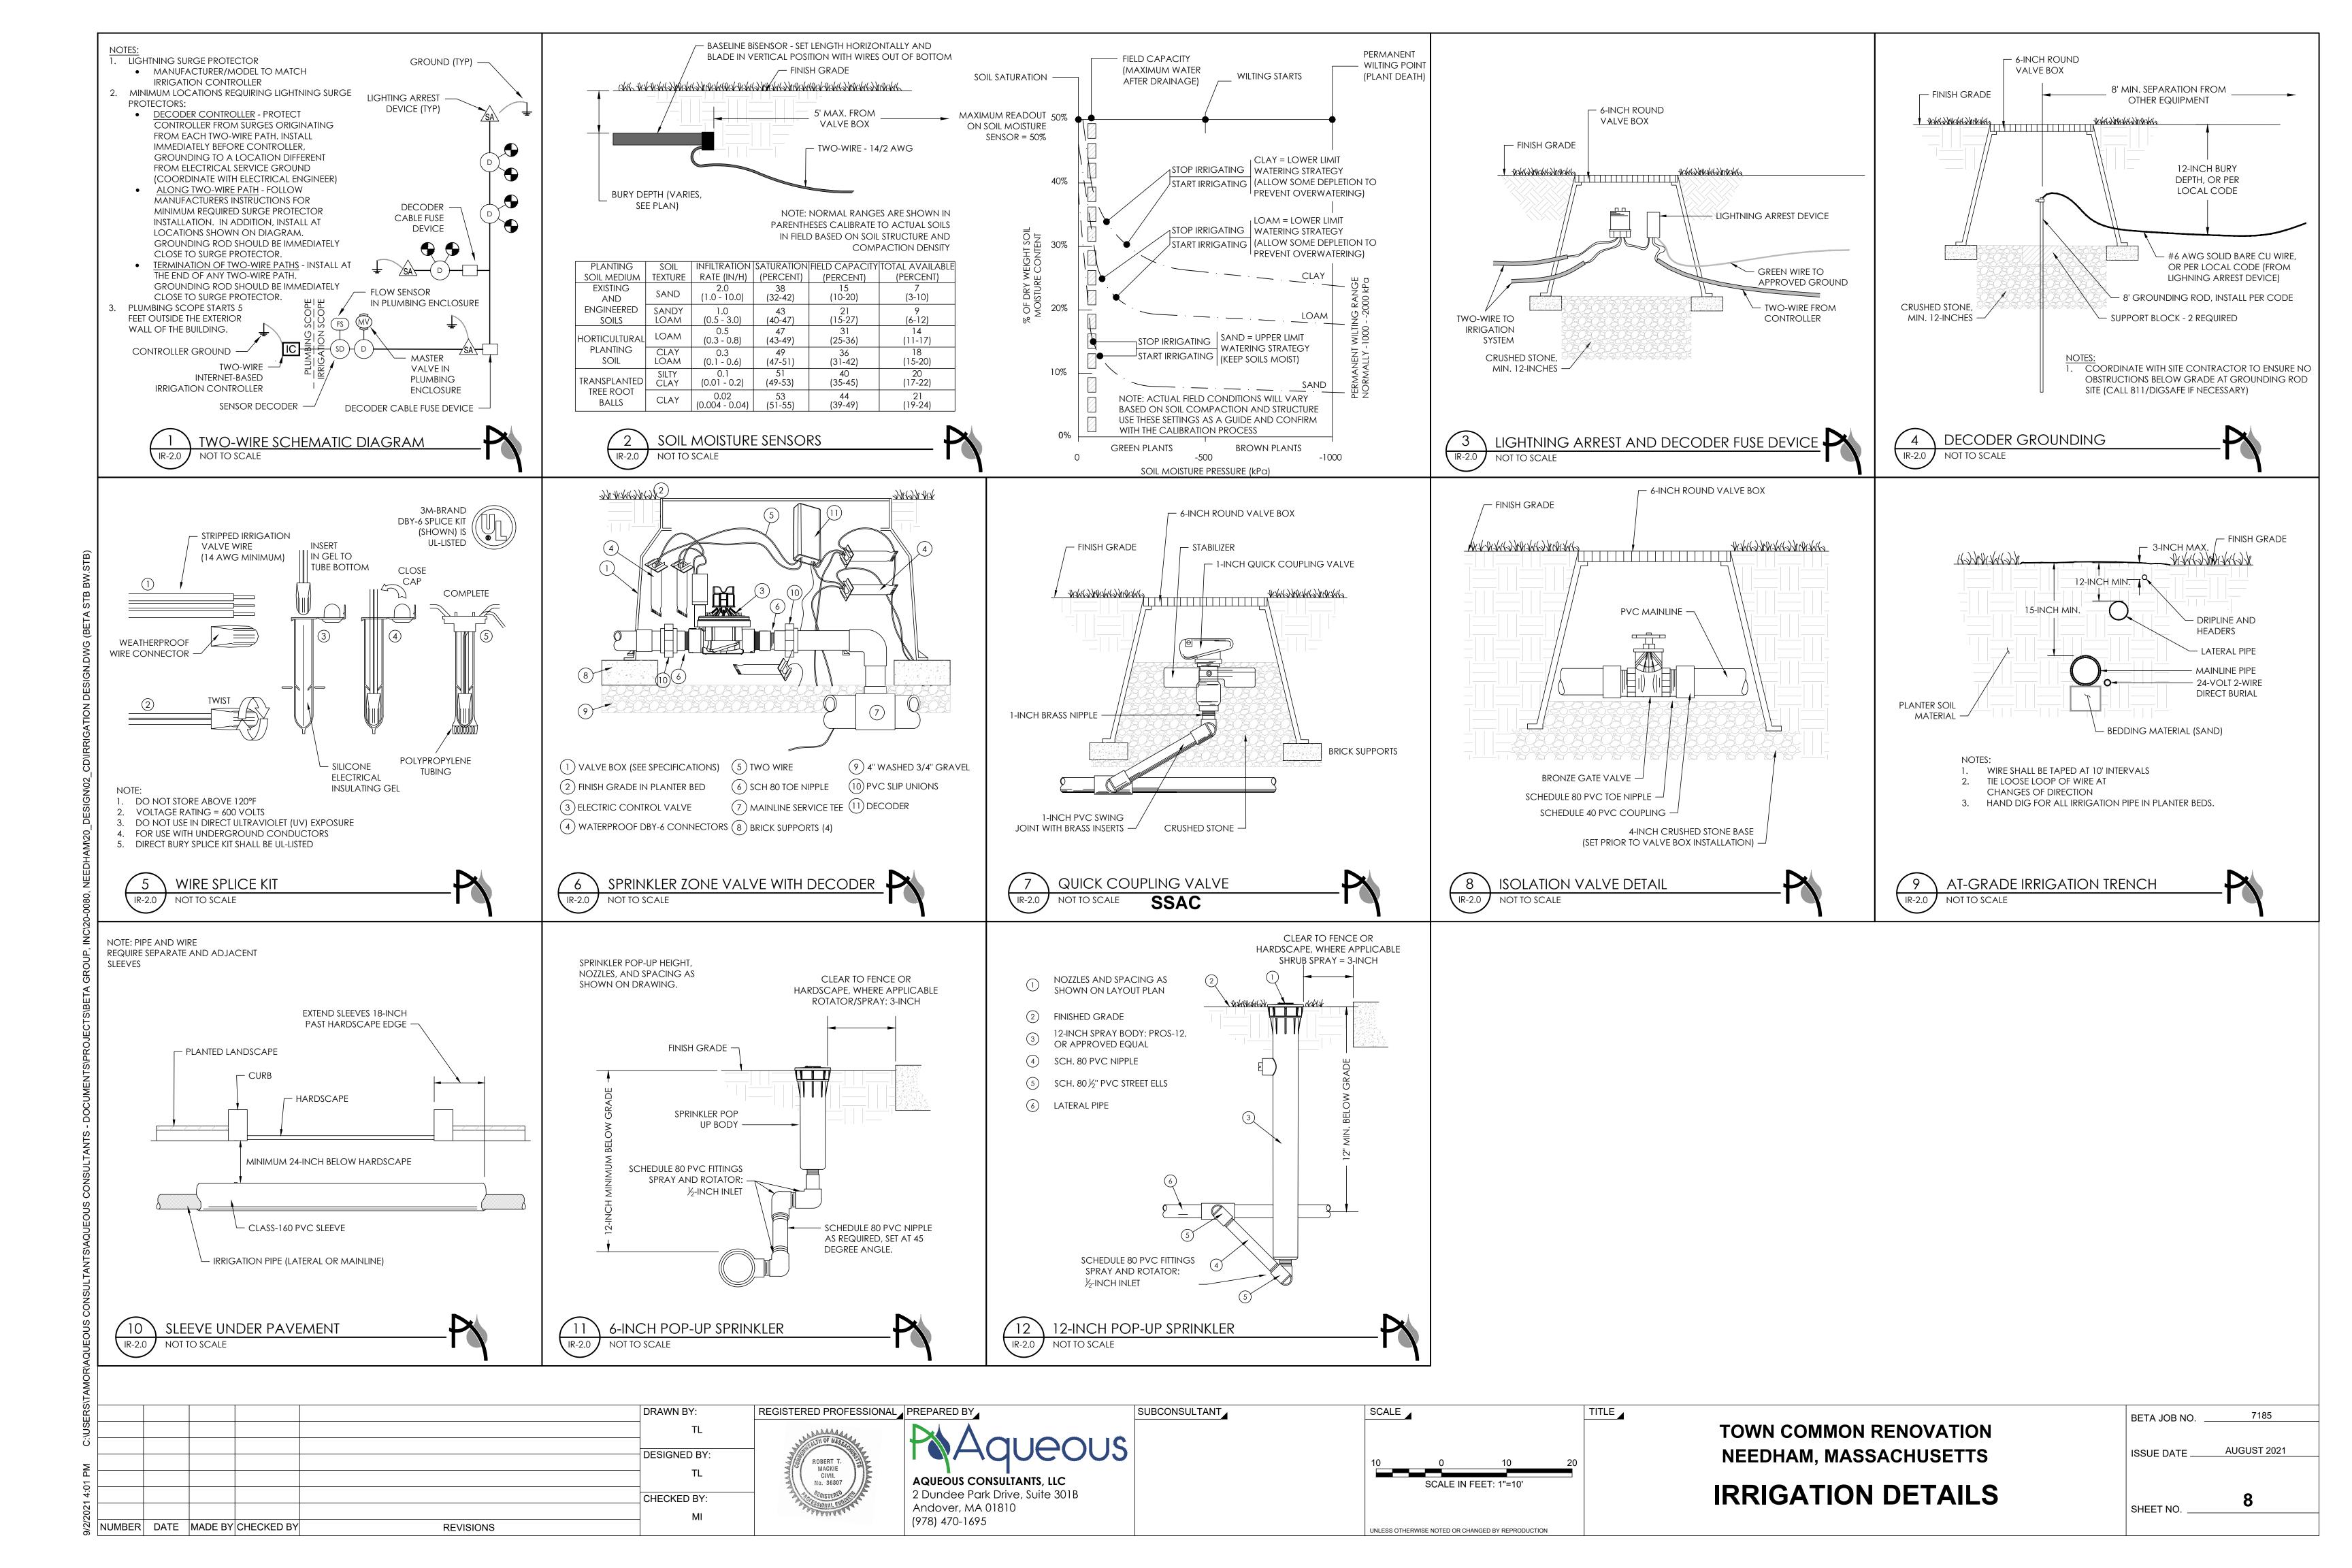

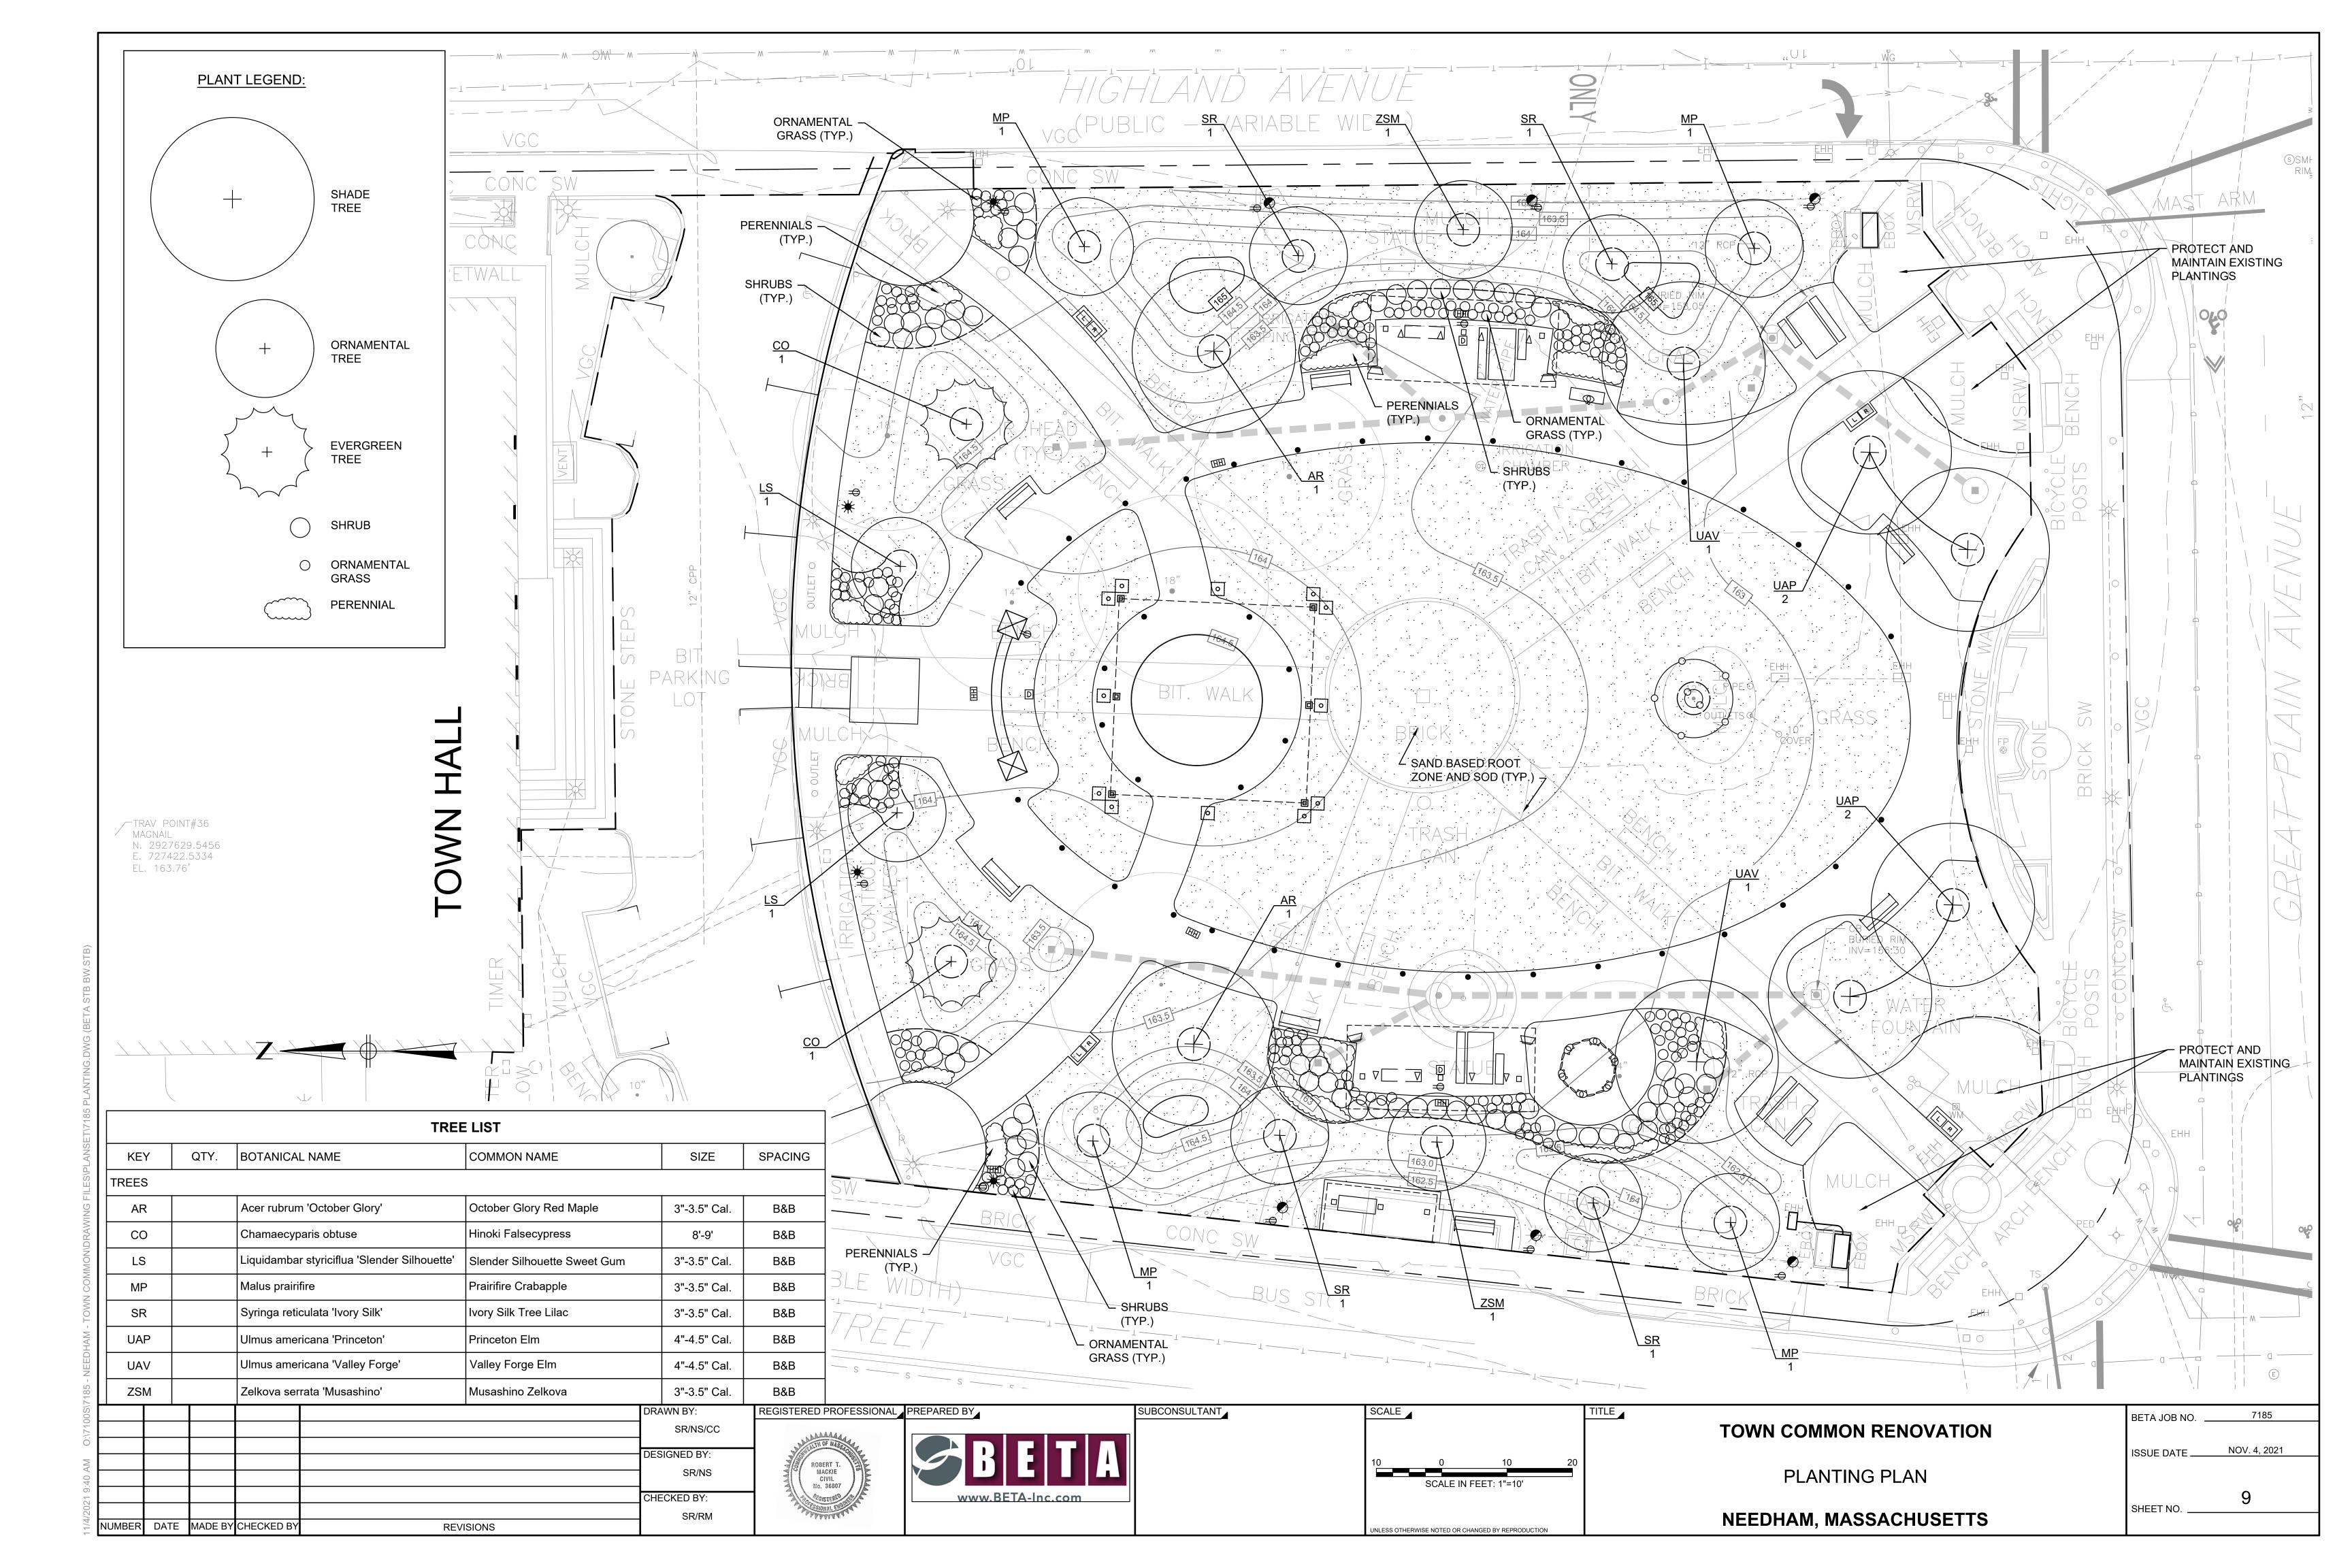

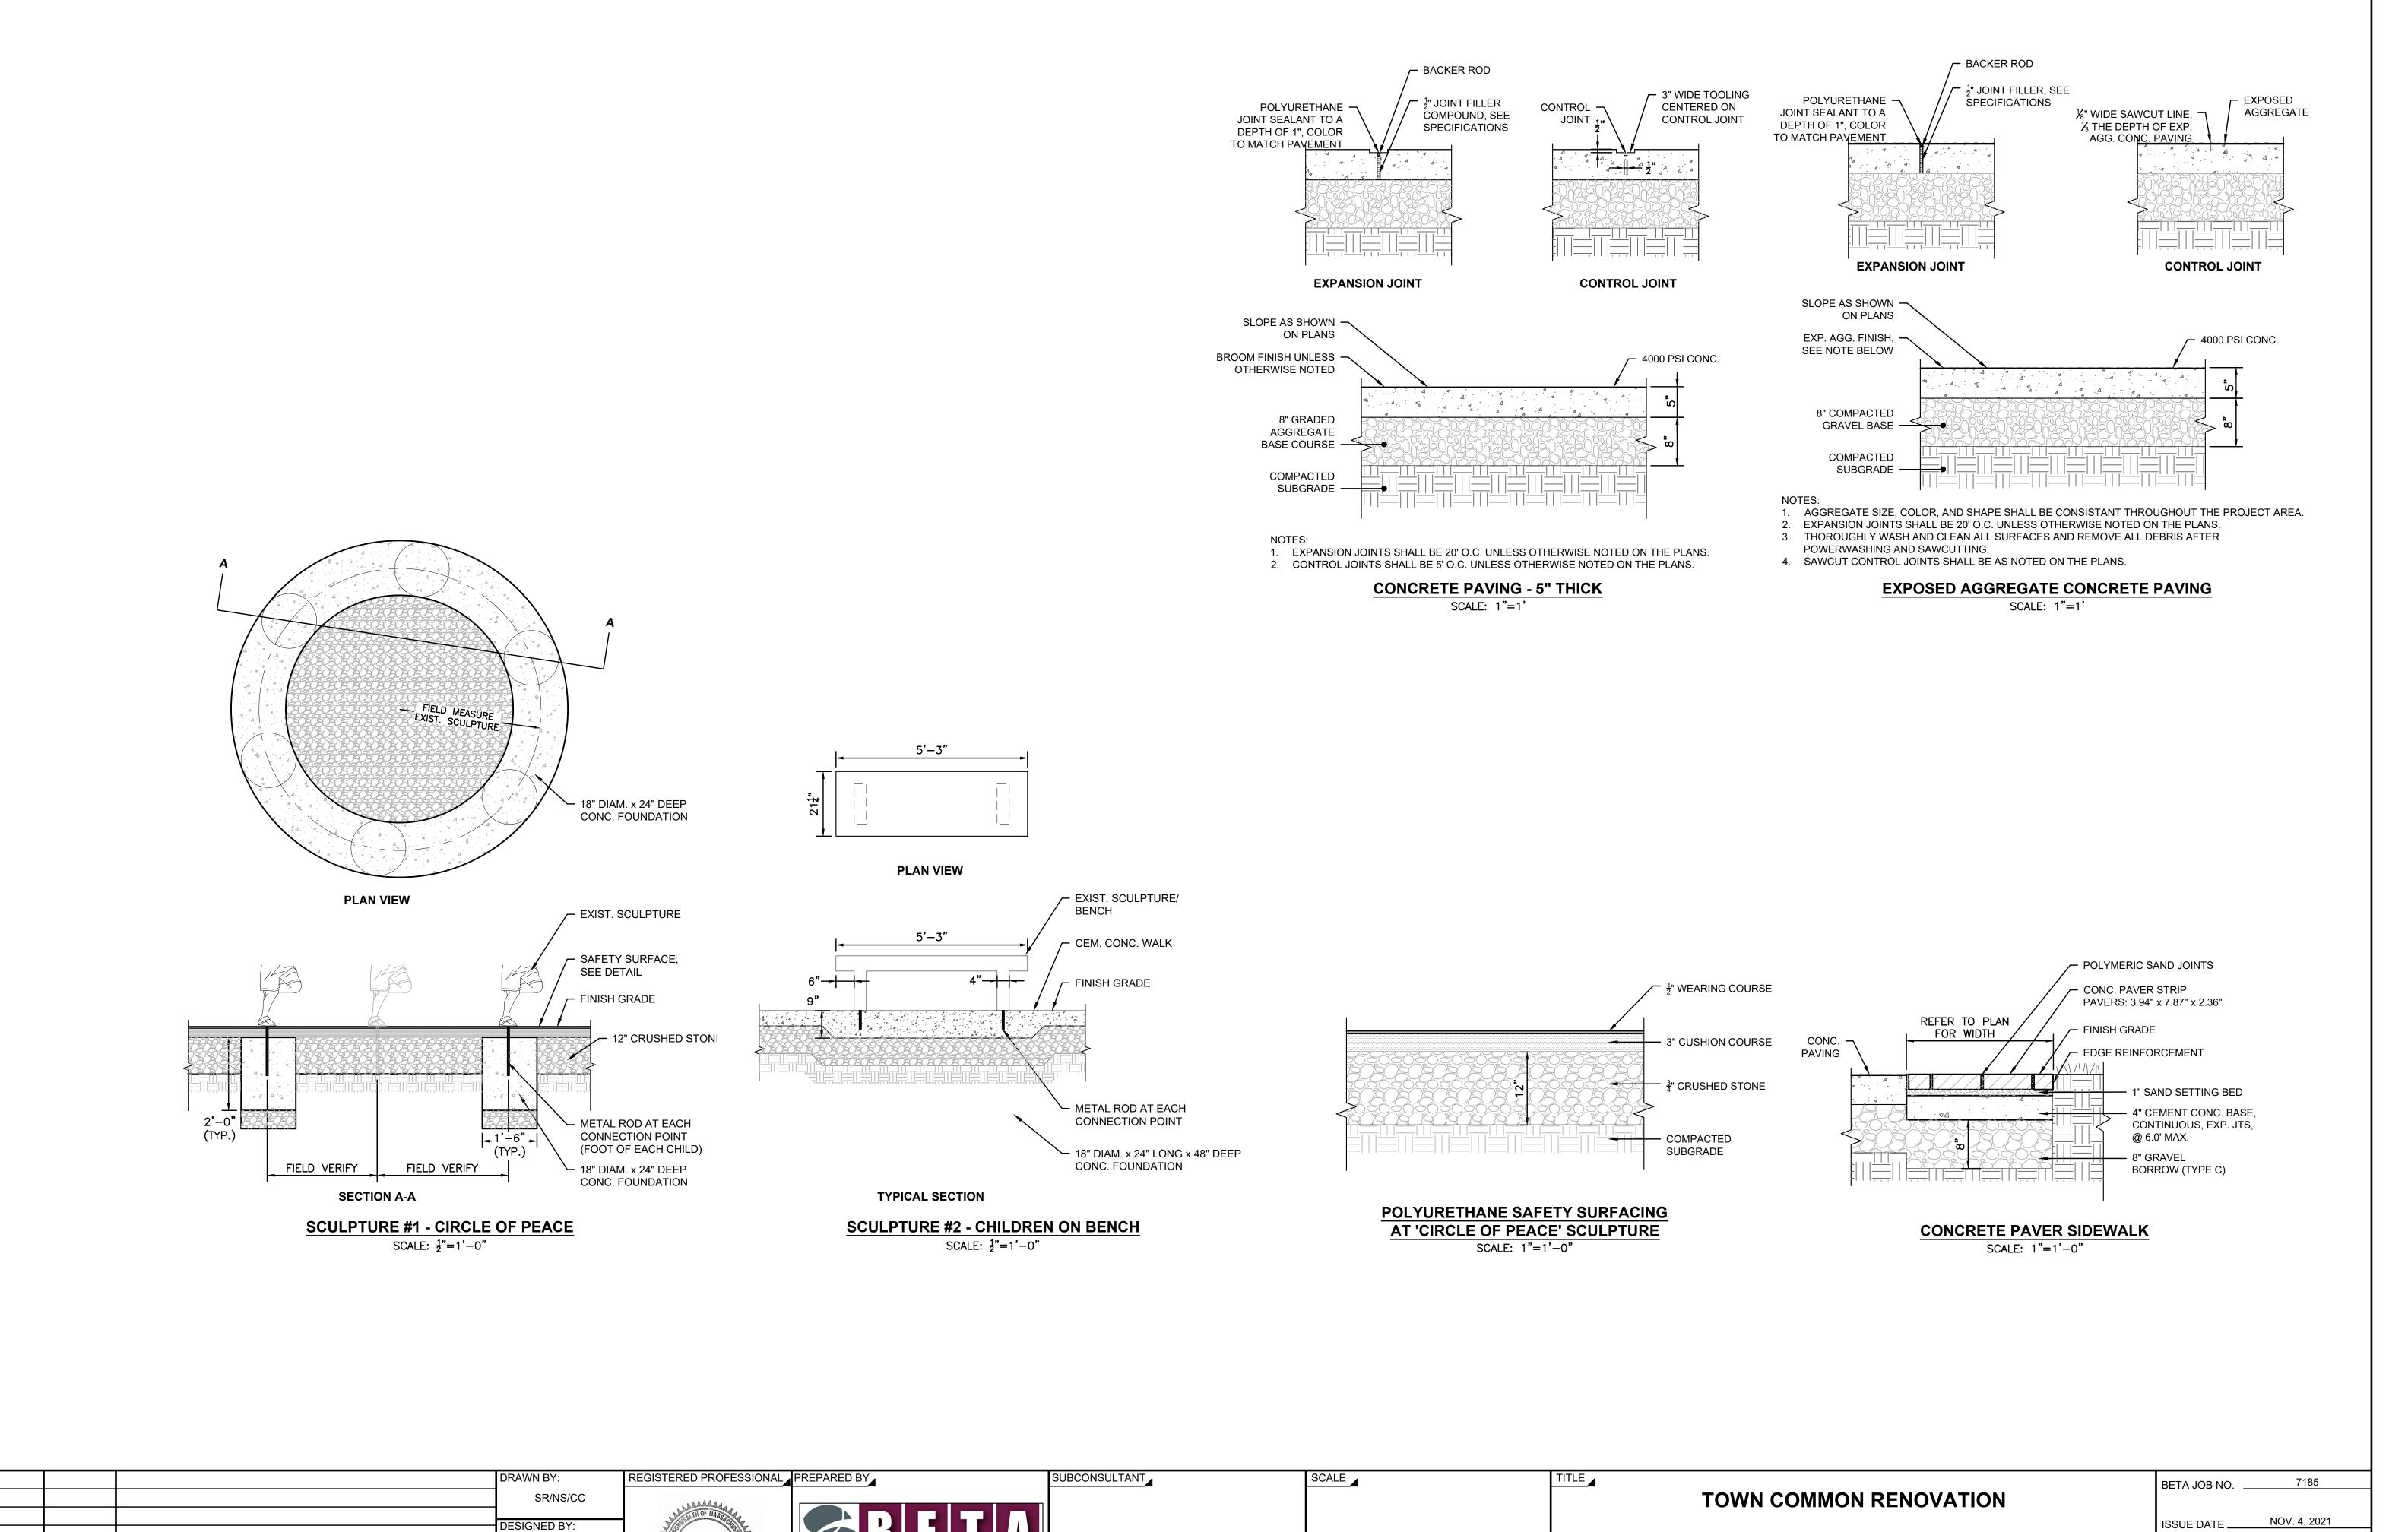

AS SHOWN

NLESS OTHERWISE NOTED OR CHANGED BY REPRODUCTION

DETAILS

NEEDHAM, MASSACHUSETTS

SHEET NO.

ROBERT T. MACKIE CIVIL No. 36807

CHECKED BY:


REVISIONS


SR/RM

www.BETA-Inc.com

11/4/2021 9:43 AM O:\/100S\/185 - NEEDHAM - 10WN COMMON/DRAWING FILES\PLANSE1\/185 LANDSCAP

DATE MADE BY CHECKED BY

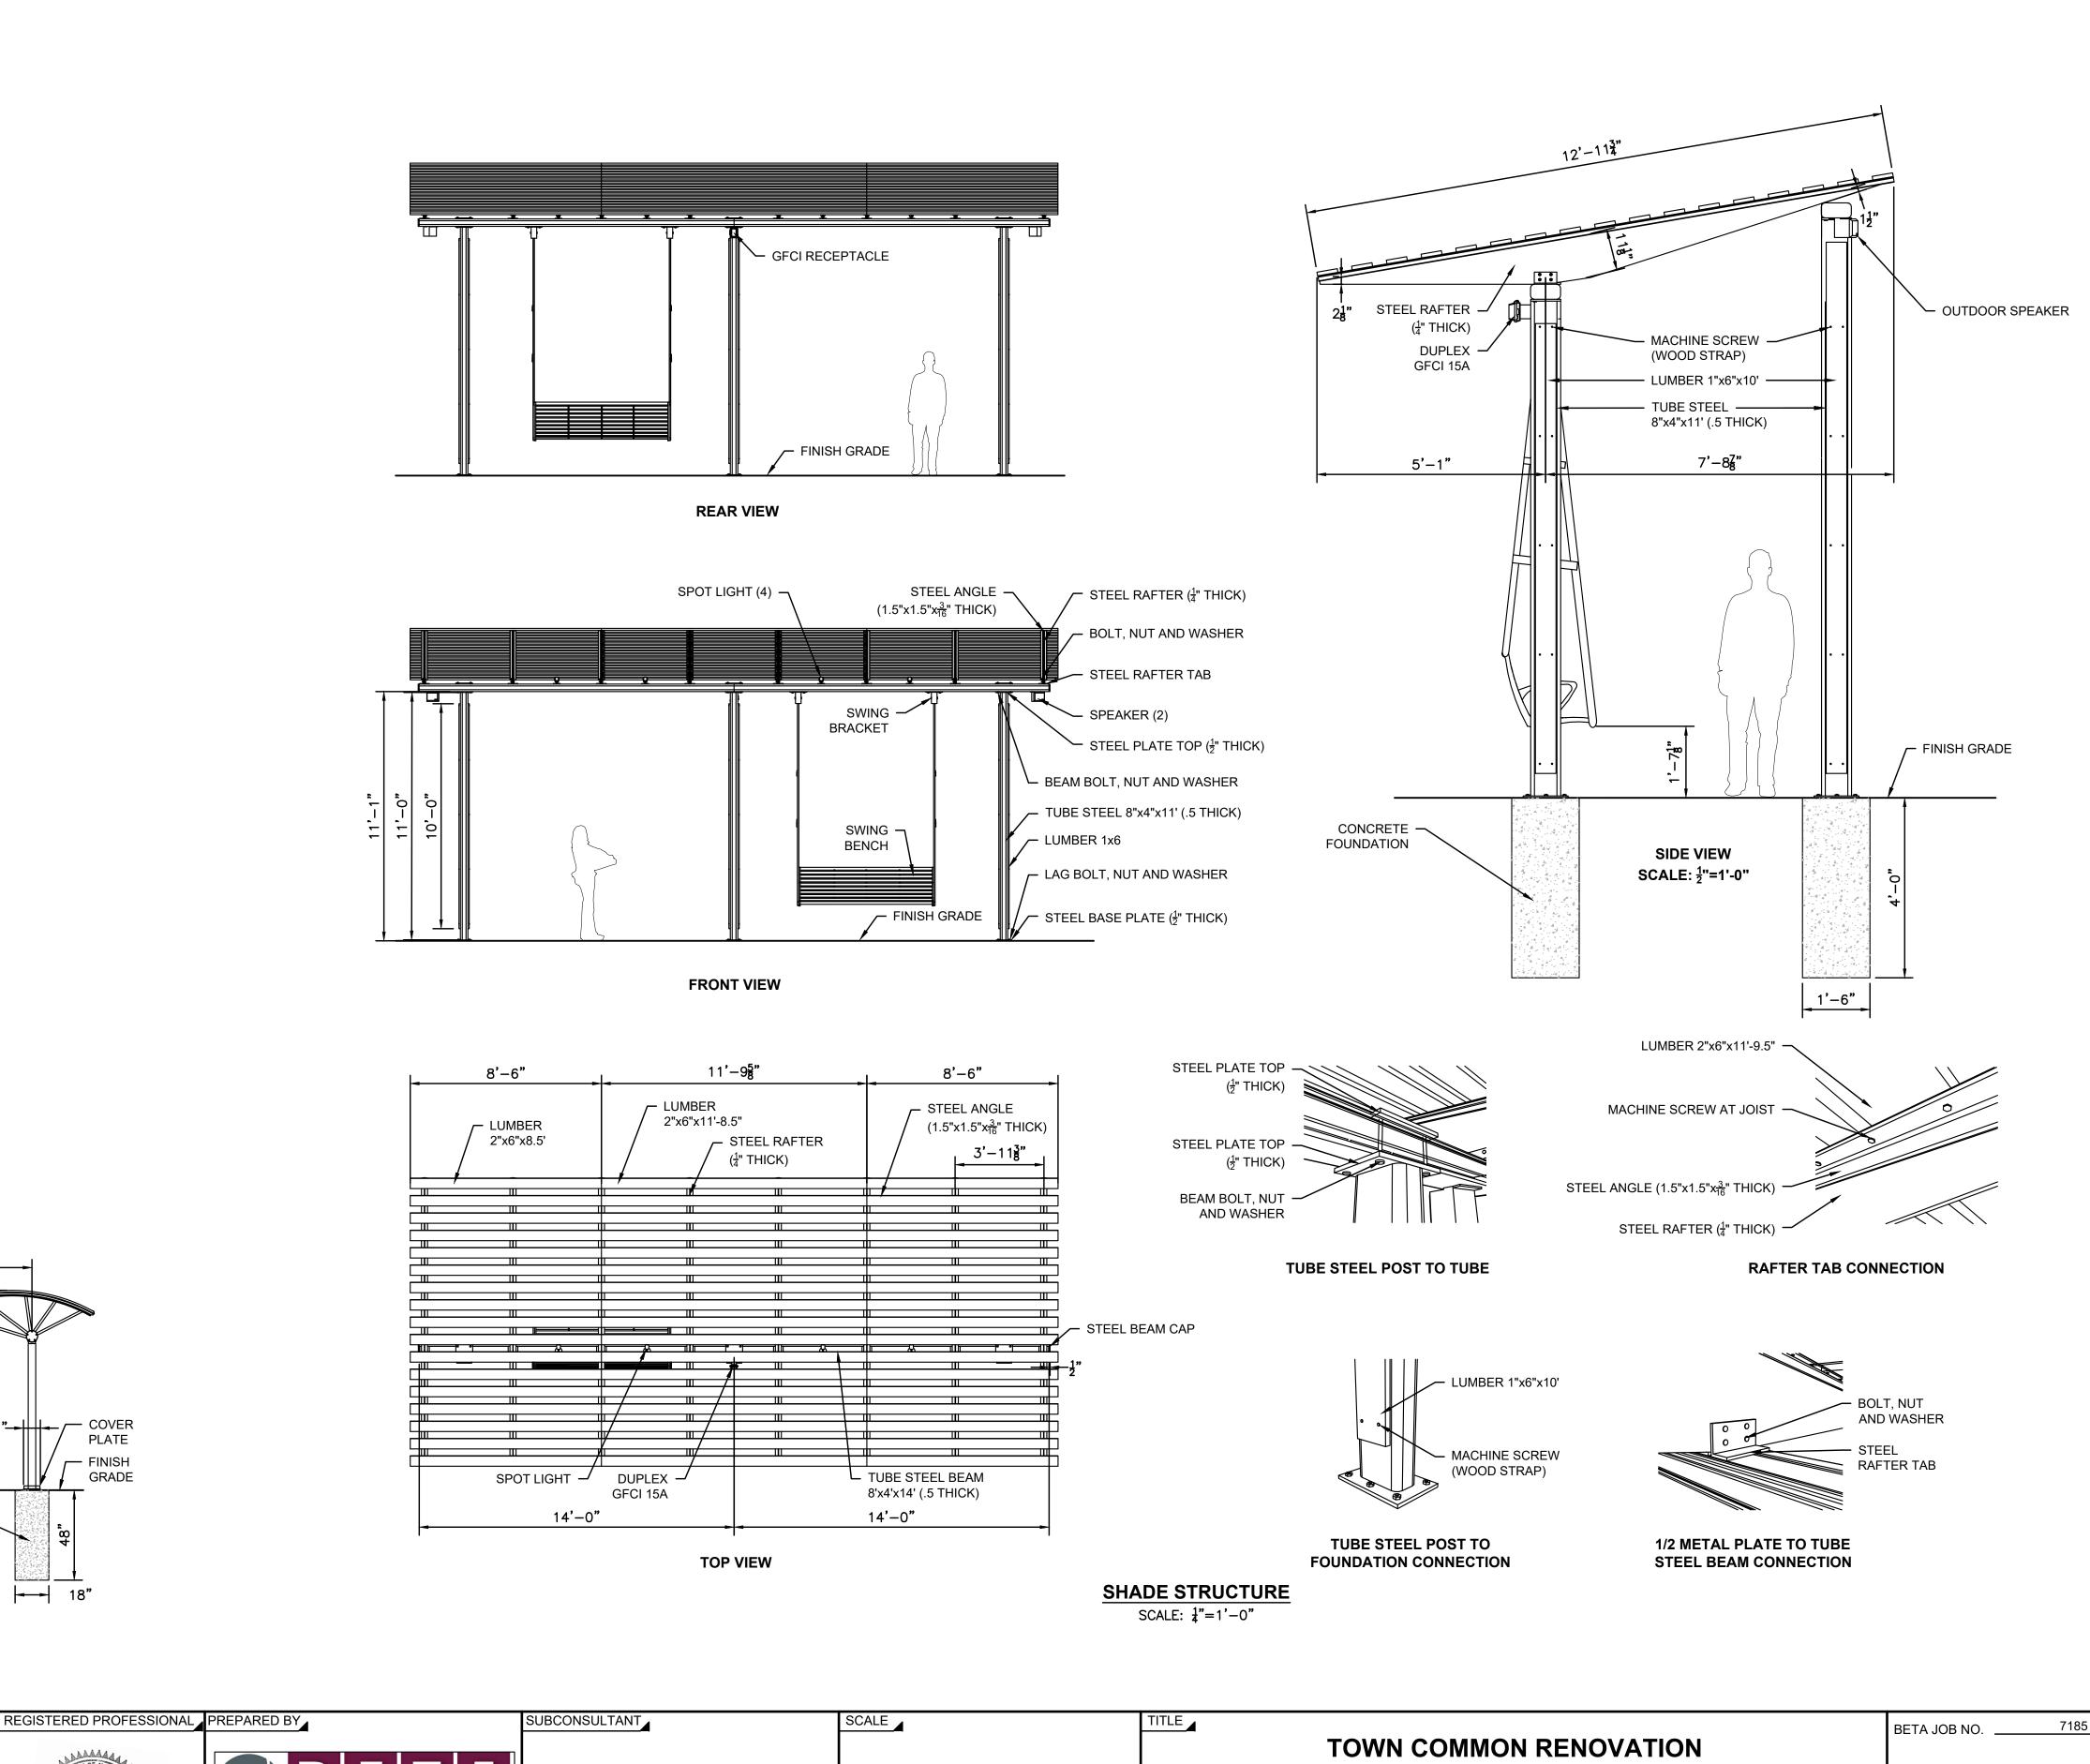

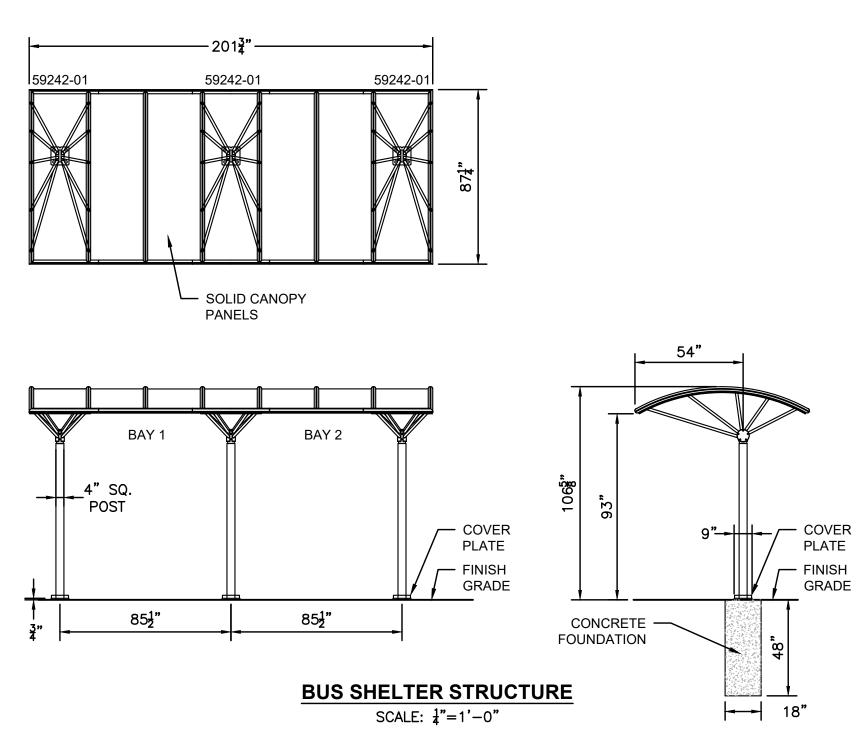

DRAWN BY:

SR/NS/CC

DESIGNED BY:

SR/NS

CHECKED BY:

SR/RM

REVISIONS





SCALE		
	AS SHOWN	

UNLESS OTHERWISE NOTED OR CHANGED BY REPRODUCTION

TOWN COMMON RENOVATION


DETAILS

NEEDHAM, MASSACHUSETTS

BETA JOB NO. 7185

ISSUE DATE NOV. 4, 2021

SHEET NO. 7185

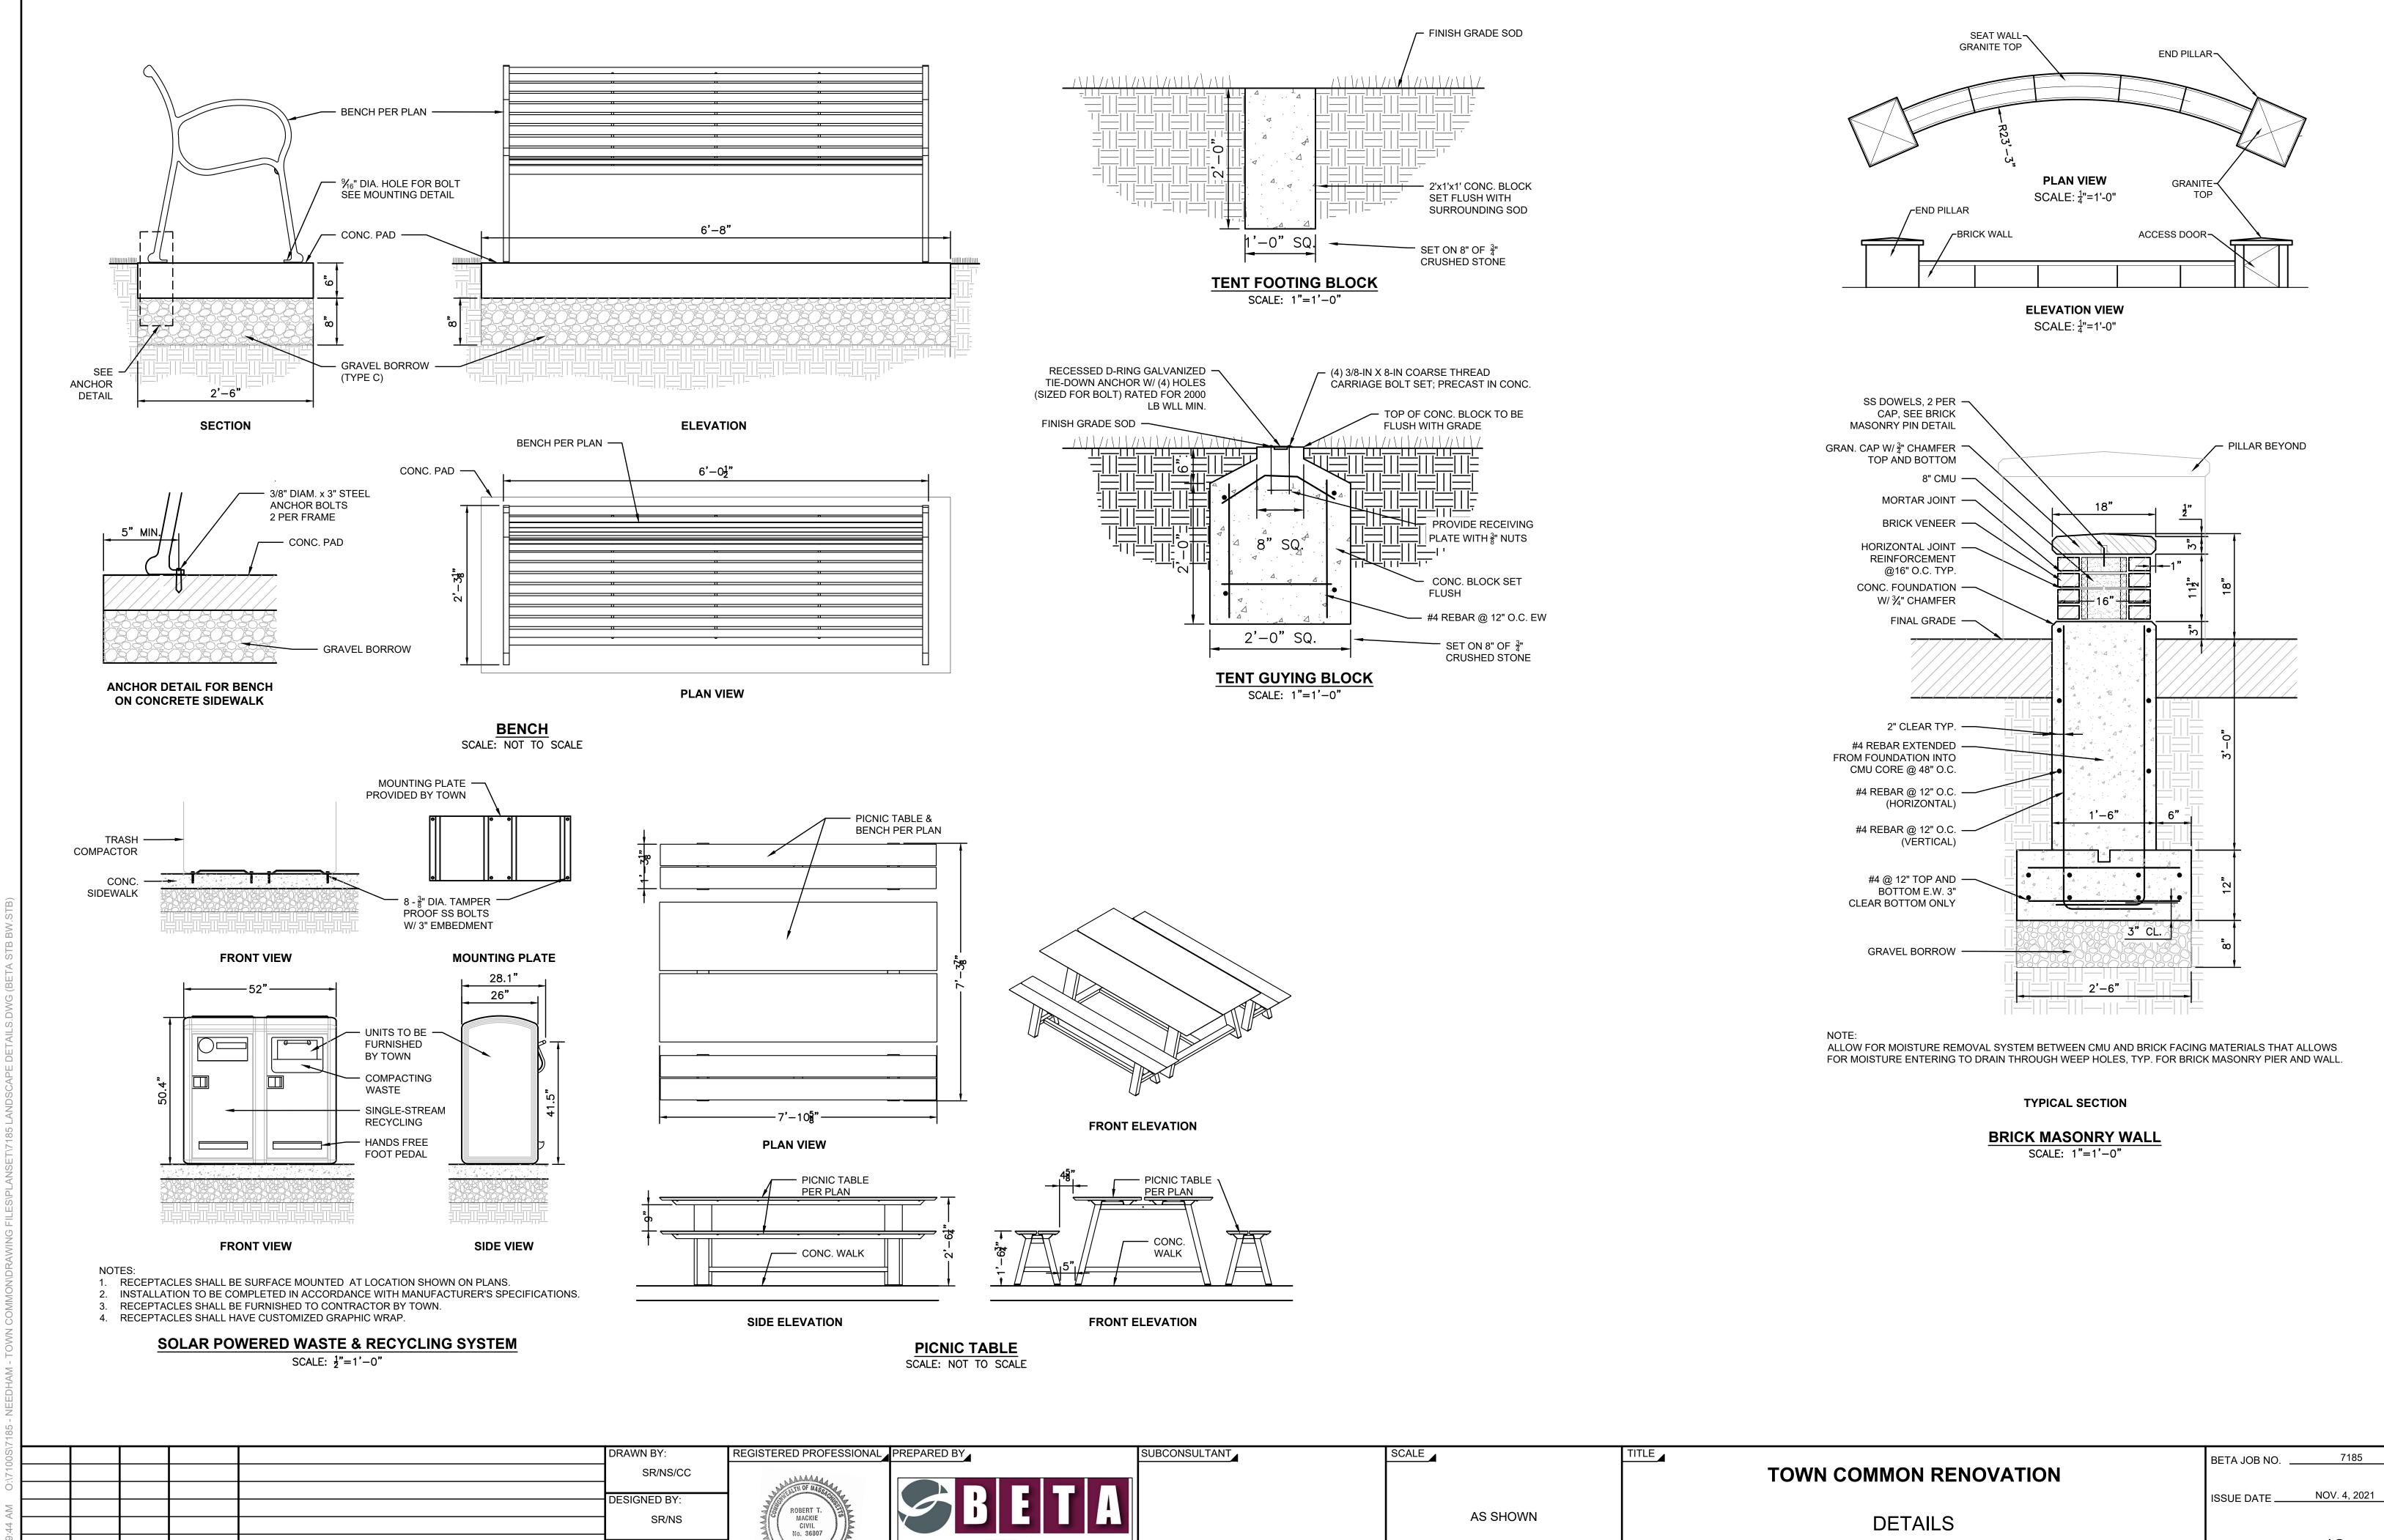

SHEET NO.

NEEDHAM, MASSACHUSETTS

NLESS OTHERWISE NOTED OR CHANGED BY REPRODUCTION


www.BETA-Inc.com

CHECKED BY:

REVISIONS

SR/RM

DATE MADE BY CHECKED BY

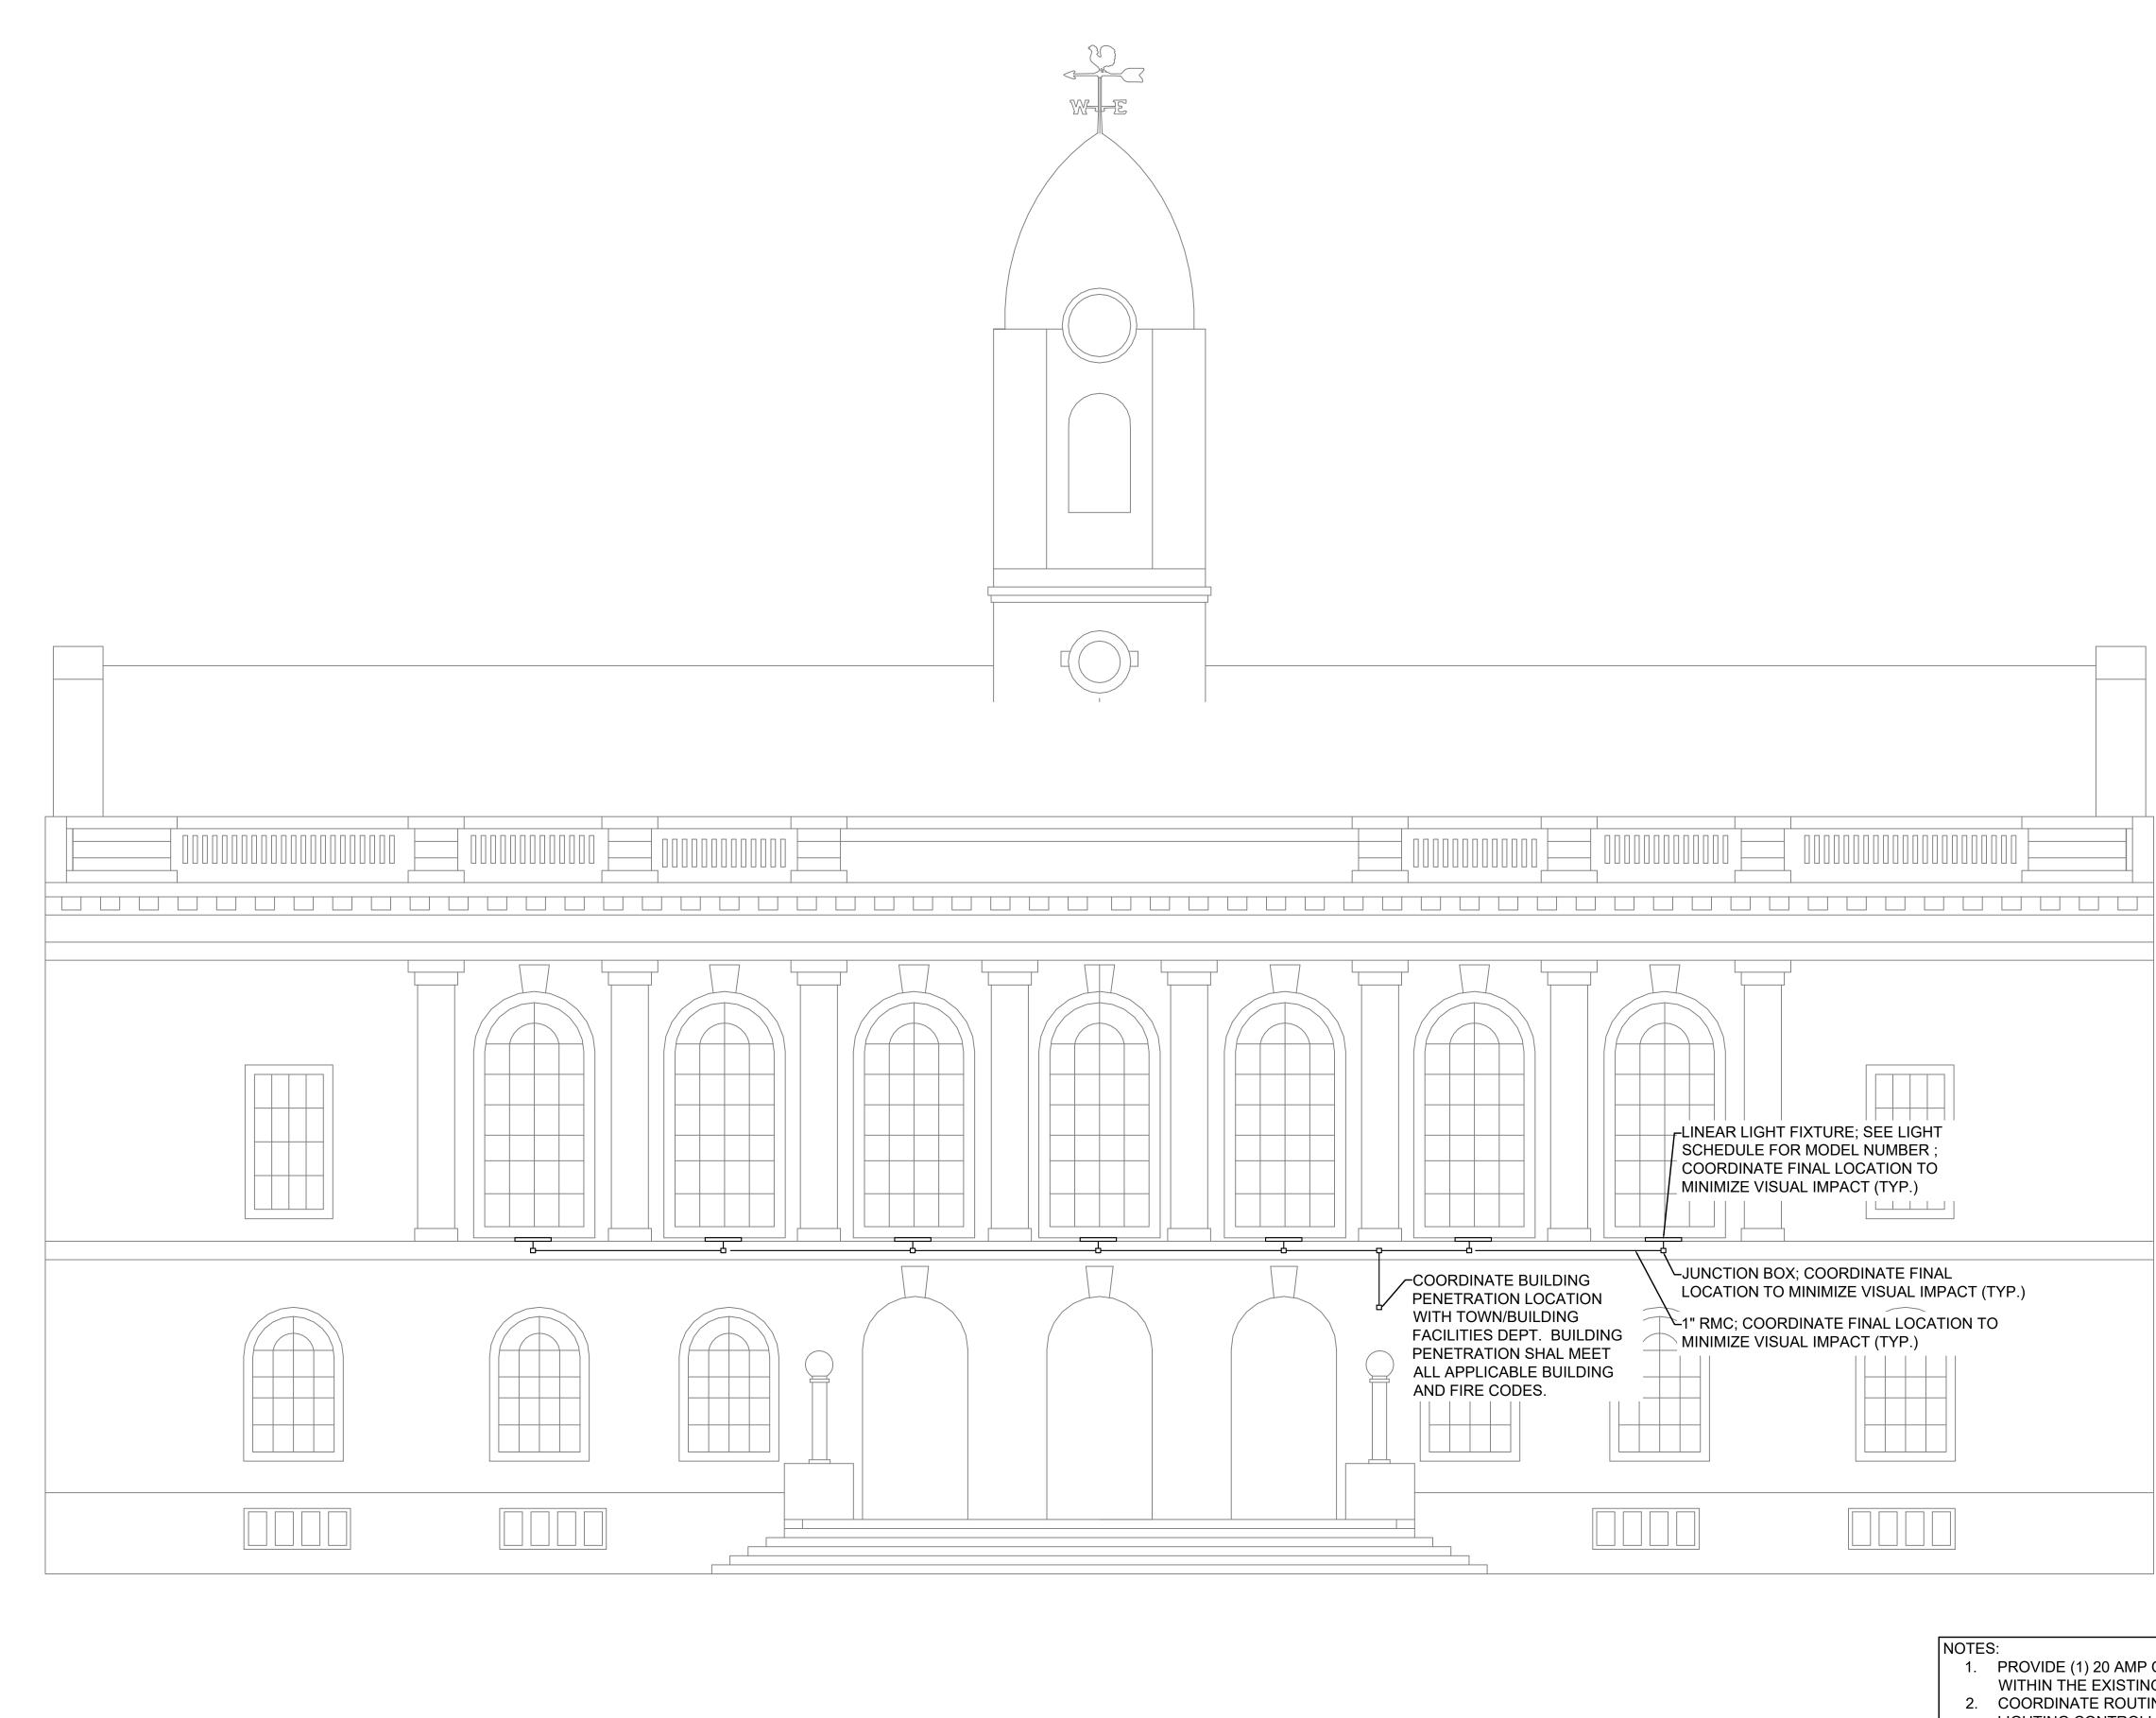

- PROVIDE (1) 20 AMP CIRCUIT AND INSTALL A NEW BREAKER WITHIN THE EXISTING ELECTRICAL PANEL.
- 2. COORDINATE ROUTING OF THE NEW CIRCUIT TO A TOUCH LED LIGHTING CONTROLLER; CAPABLE OF CHANGING COLORS, CREATING ZONES, DIMMING AND TIMER FUNCTIONS.

						DRAWN BY:	REGISTERED PROFESSIONAL PREPARED BY	SUBCONSULTANT	SCALE	TITLE
	_					SR/NS/CC	THE			TOWN COMMON RENOVATION
>	+					DESIGNED BY:	ROBERT T.			
ī	\top					SR/NS	MACKIE CIVIL No. 36807		AS SHOWN	ELECTRICAL DETAILS
						CHECKED BY:	www.BE	A-Inc.com		
1				011501(55.5)(SR/RM	NOWAL TO STATE OF THE PARTY OF			NEEDHAM, MASSACHUSETTS
NOWRER	:K L	DATE	IMADE BY	CHECKED BY	REVISIONS				UNLESS OTHERWISE NOTED OR CHANGED BY REPRODUCTION	


BETA JOB NO. 7185

ISSUE DATE NOV. 4, 2021

SHEET NO. _____

ELECTRICAL NOTES:

- 1. ALL WORK TO BE COMPLETED IN ACCORDANCE WITH THE LATEST APPLICABLE STANDARDS OF ANSI, NEMA, UL, NFPA-70, AND THE NATIONAL ELECTRICAL CODE WITH REGARDS TO MATERIAL, DESIGN, AND CONSTRUCTION.
- 2. THIS DRAWING IS FOR INFORMATION ONLY. THE CONTRACTOR SHALL VERIFY ALL LOCATIONS, DEVICES, MATERIALS, AND EQUIPMENT, PRIOR TO THE START OF ANY WORK.
- 3. CONTRACTOR SHALL NOTIFY DIG SAFE AT 1-888-DIG-SAFE, AT LEAST 72 HOURS PRIOR TO BEGINNING ANY EXCAVATION.
- 4. PVC CONDUIT AND FITTINGS SHALL CONFORM TO ANSI/NEMA SPECIFICATIONS, TC-2, TC-3 AND UL-651.
- 5. CONTRACTOR SHALL OBTAIN ALL NECESSARY INSPECTIONS AND COORDINATE ALL WORK WITH THE OWNER AND THE TOWN OF NEEDHAM. TRENCHES SHALL BE INSPECTED PRIOR TO BACKFILLING.
- 6. LOCATIONS OF ALL UTILITIES ARE APPROXIMATE AND ARE PROVIDED FOR INFORMATION ONLY.
- 7. CONTRACTOR TO BALANCE THE NUMBER OF LIGHTING FIXTURES ON EACH CIRCUIT
- 8. CONTRACTOR TO LOCATE ALL ELECTRICAL EQUIPMENT AS DIRECTED BY THE OWNER, ARCHITECT & ENGINEER.

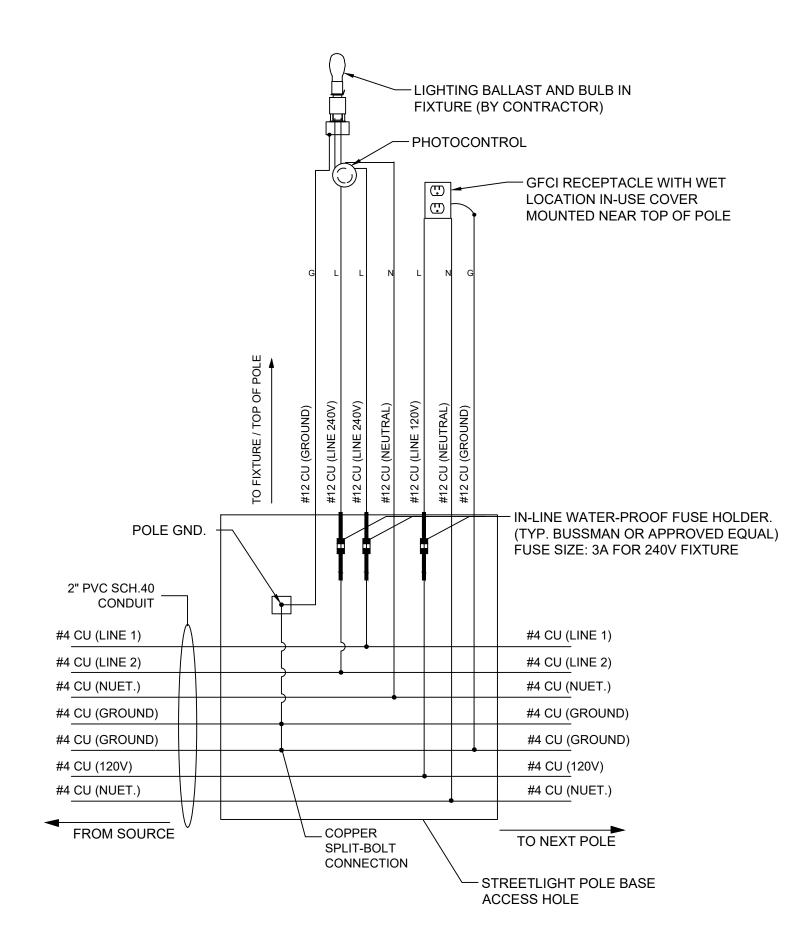

TYPICAL STREETLIGHT WIRING DETAIL NOT TO SCALE

_						
5						DRAWN BY:
-						SR/NS/CC
)						DEGIONED DV
						DESIGNED BY:
L D						SR/NS
						011501755 577
7						CHECKED BY:
7						SR/RM
	NUMBER	DATE	MADE BY	CHECKED BY	REVISIONS	





SUBCONSULTANT

SCALE **AS SHOWN**

TOWN COMMON RENOVATION ELECTRICAL DETAILS


NEEDHAM, MASSACHUSETTS


7185 BETA JOB NO. NOV. 4, 2021 ISSUE DATE ___

SHEET NO.

NEW DISTRIBUTION PANEL SCHEDULE - P1

PHASE: 1			WIRES: 3 VOLTAGE: 120/240V	MAINS: 200A. MAIN C.B.	42 CIRCUIT			
CIRCUIT	BREAKER		EAKER DESCRIPTION OF LOAD		CABLE	CONDUIT	REMARKS	
CIRC	FRAME	POLES(N-NEUTRAL)	TRIP	DESCRIPTION OF LOAD	CABLE	CONDOTT	REWARKS	
М	200	2P	200	MAIN CIRCUIT BREAKER	3W#3/0AWG & #6AWG GND	1-3"NM SCH80		
1	30	2P	30	LIGHTING CIRCUIT #1 (POLES LP#1-LP#10,)	3W#4AWG & #4 GND	1-2"NM SCH80	CONTROLLED BY PHOTOCELL IN EACH POLE	
2	30	2P	30	SHADE STRUCTURE RECEPTACLES (2 TOTAL)	2W#8AWG & #10 GND	1-2"NM SCH80	CONTROLLED BY BREAKER (ALWAYS ON)	
3	30	2P	30	IN WALL AND IN GROUND RECEPTACLES (3 TOTAL)	2W#8AWG & #10 GND	1-2"NM SCH80	CONTROLLED BY BREAKER (ALWAYS ON)	
4	30	2P	30	POLE RECEPTACLES (POLES LP#11-LP#21)	2W#4AWG & #4 GND	1-2"NM SCH80	CONTROLLED BY PHOTOCELL W/BYPASS IN CABINET	
5	30	2P	30					
6	30	1P	30					
7	30	1P	30					
8	30	1P	30					
9	20	1P	20					
10	20	1P	20					
11	20	1P	20					
12	20	1P	20					
13	30	2P	30					
14	20	1P	20	FLAG AND ARCH UPLIGHTS (6 LIGHTS)	2W#8AWG & #10 GND	1-2"NM SCH80	CONTROLLED BY TIMECLOCK & PHOTOCELL IN CABINET	
15	20	1P	20	TIME CLOCK POWER	2W#12AWG & #12 GND	1-1"NM SCH80		
16	20	1P	20	RECEPTACLE IN CABINET	2W#12AWG & #12 GND	1-1"NM SCH80		
17	20	1P	20	PHOTOCONTROL CONTACTOR POWER	2W#12AWG & #12 GND	1-1"NM SCH80		

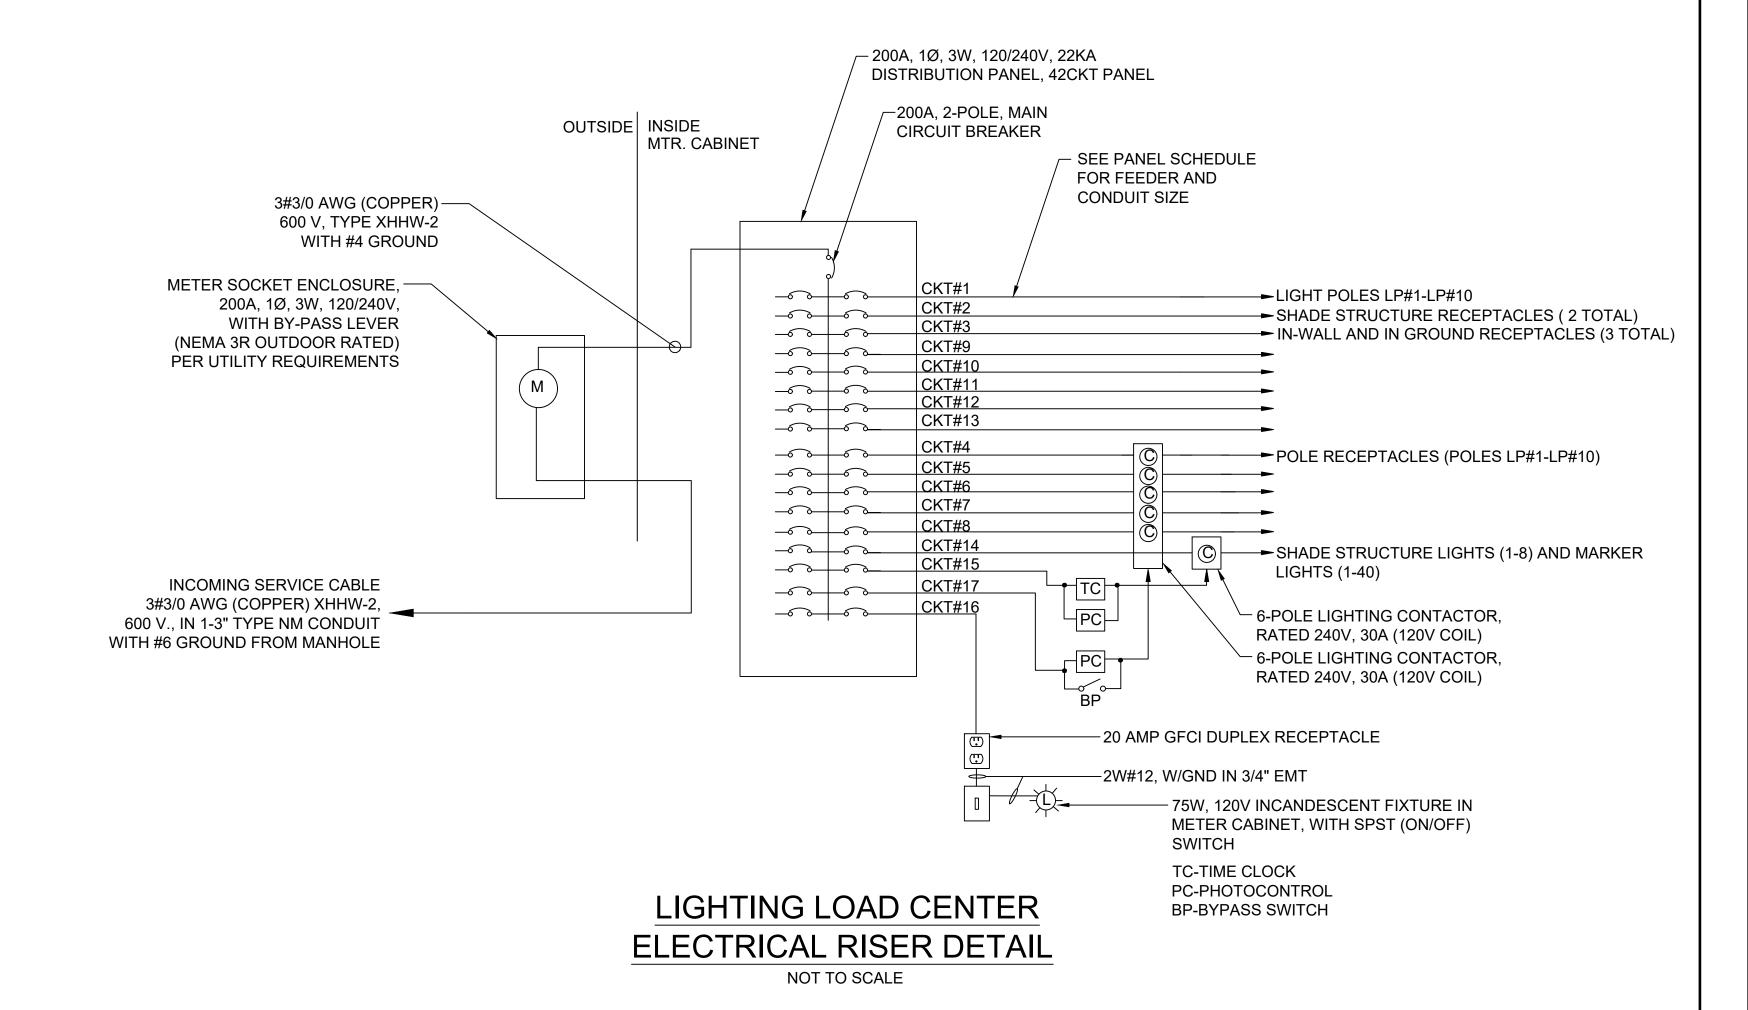


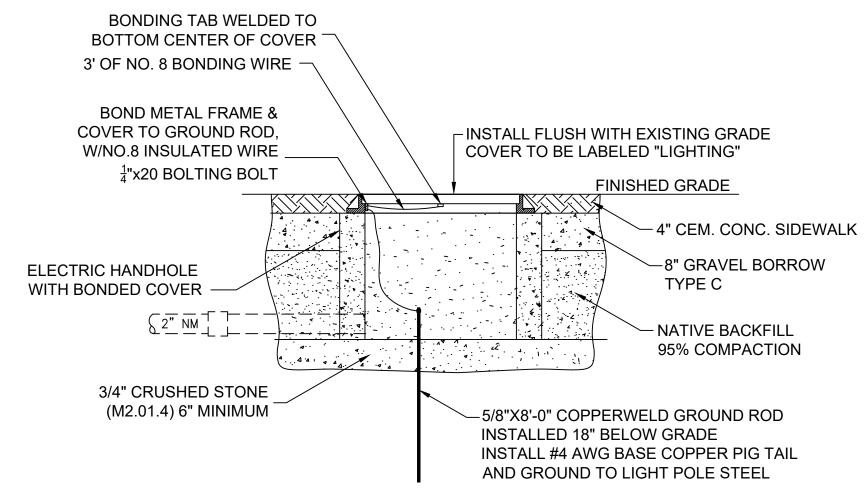

HANDHOLE INSTALLATION NOTES:

- 1. HANDHOLE ORIENTATION TO BE SUCH THAT ALL SUPPLY DUCTS ENTER ON SAME SHORT SIDE.
- 2. SIZE AND NUMBER OF CONDUITS AS REQUIRED.
- 3. CONDUIT LOCATIONS SHOWN ARE TYPICAL.


INSTALLATION DETAIL PRECAST ELECTRIC HANDHOLE NOT TO SCALE

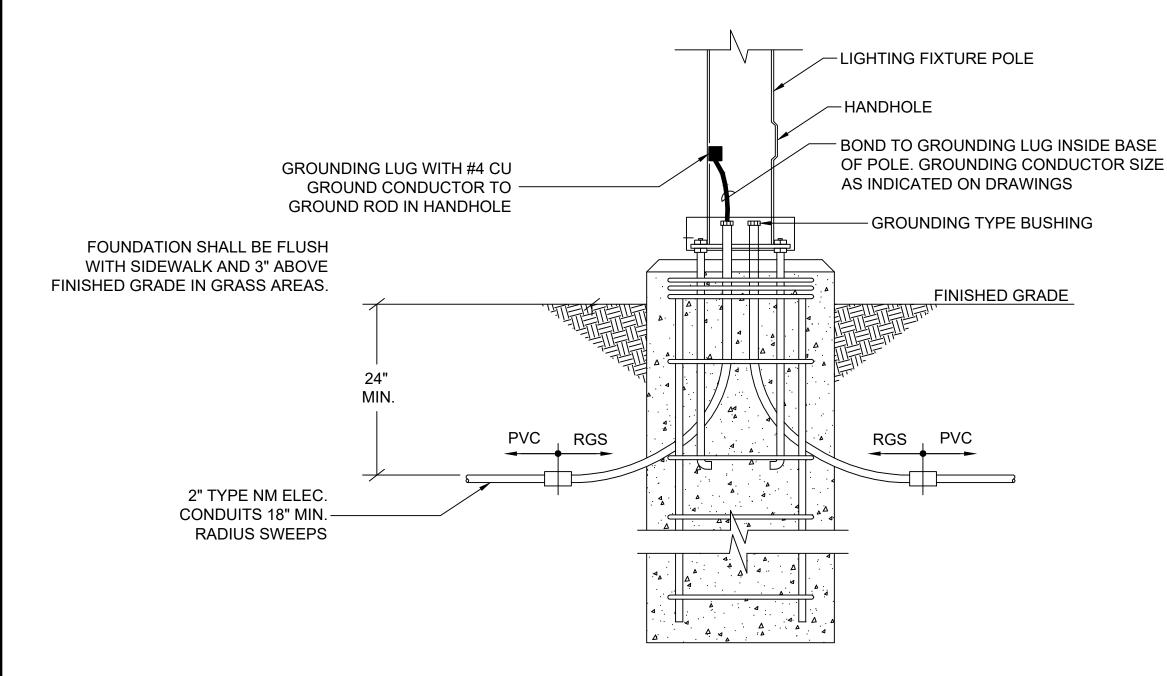


LIGHT POLE FOUNDATION NOTES:


- 1. BOLT PATTERN SHOWN IS TYPICAL AND NOT FOR CONSTRUCTION CONTRACTOR TO PROVIDE BOLT PATTERN DETAILS BASED ON SELECTED MANUFACTURER.
- 2. PROVIDE REBAR DETAIL FROM PRECAST CONCRETE VENDOR FOR APPROVAL.
- 3. CONDUIT LOCATIONS SHOWN ARE TYPICAL.


LIGHT POLE FOUNDATION CONDUIT DETAIL NOT TO SCALE

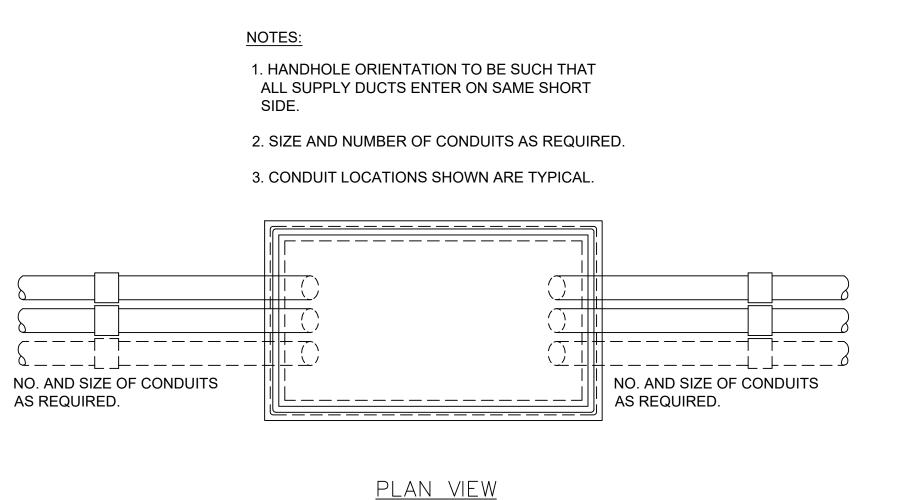


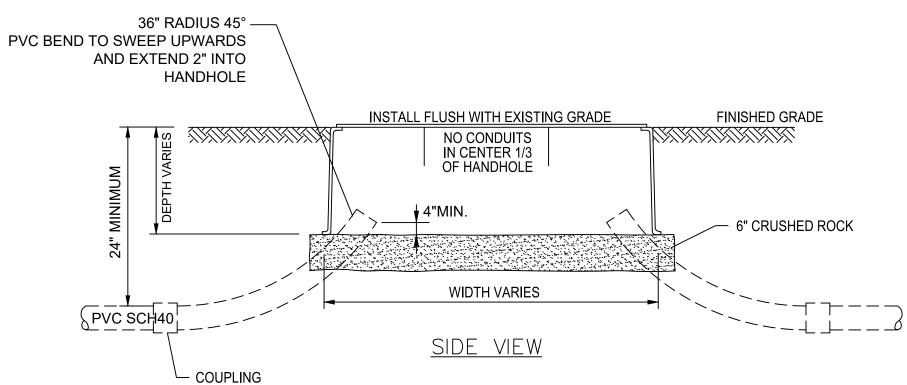

INSTALLATION DETAIL COMPOSITE ELECTRIC HANDHOLE NOT TO SCALE

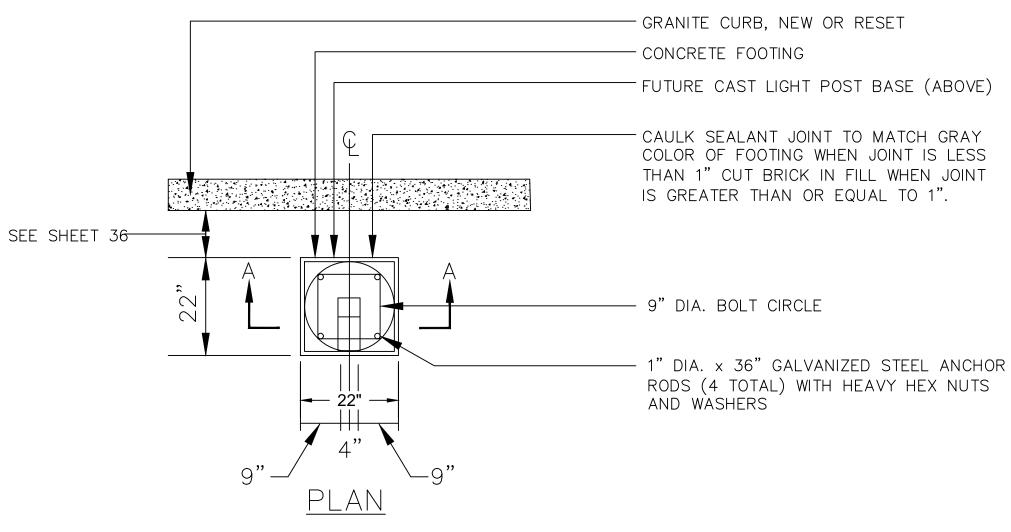

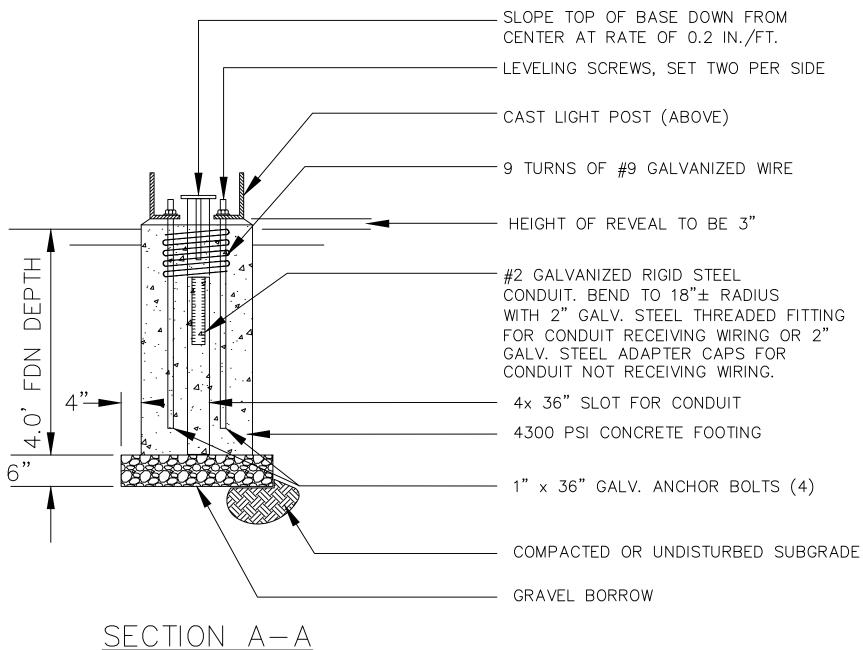

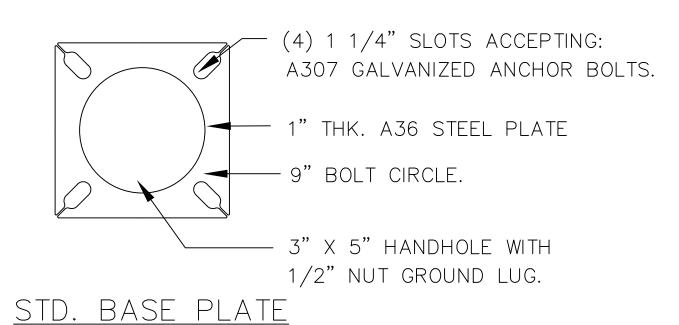

LIGHT POLE FOUNDATION DETAIL

NOT TO SCALE





AS SHOWN

ILESS OTHERWISE NOTED OR CHANGED BY REPRODUCTION

TITLE

TOWN COMMON RENOVATION


ELECTRICAL DETAILS


NEEDHAM, MASSACHUSETTS

BETA JOB NO. 7185

ISSUE DATE NOV. 4, 2021

SHEET NO. 15

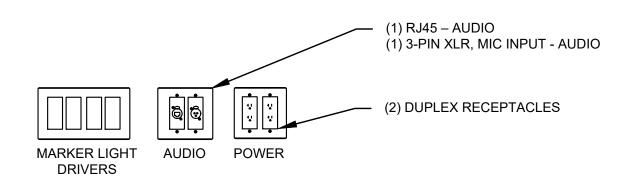


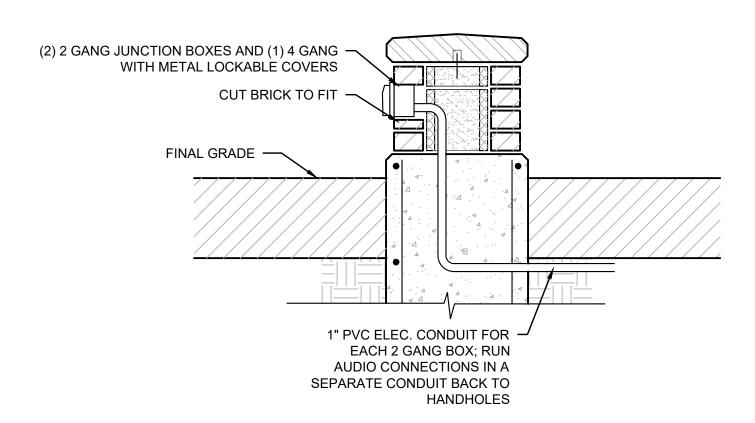

TYPICAL SECTION


WALL MOUNTED DRIVERS, AUDIO AND GFCI RECEPTACLES

SCALE: 1"=1'-0"

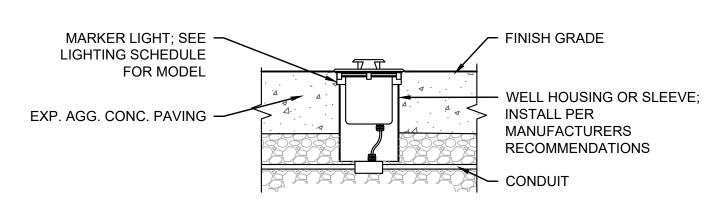


TYPICAL SECTION

RECESSED WALKWAY LIGHT SCALE: NTS

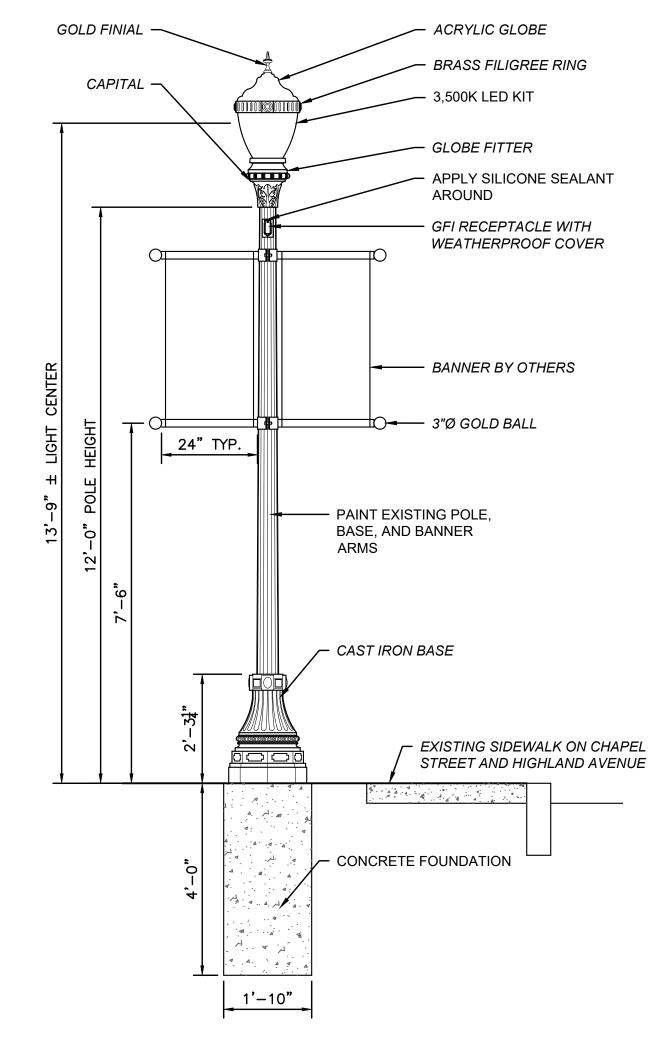


EXISTING POST TOP LIGHT ON NEW FOUNDATION SCALE: $\frac{1}{2}$ "=1'-0"

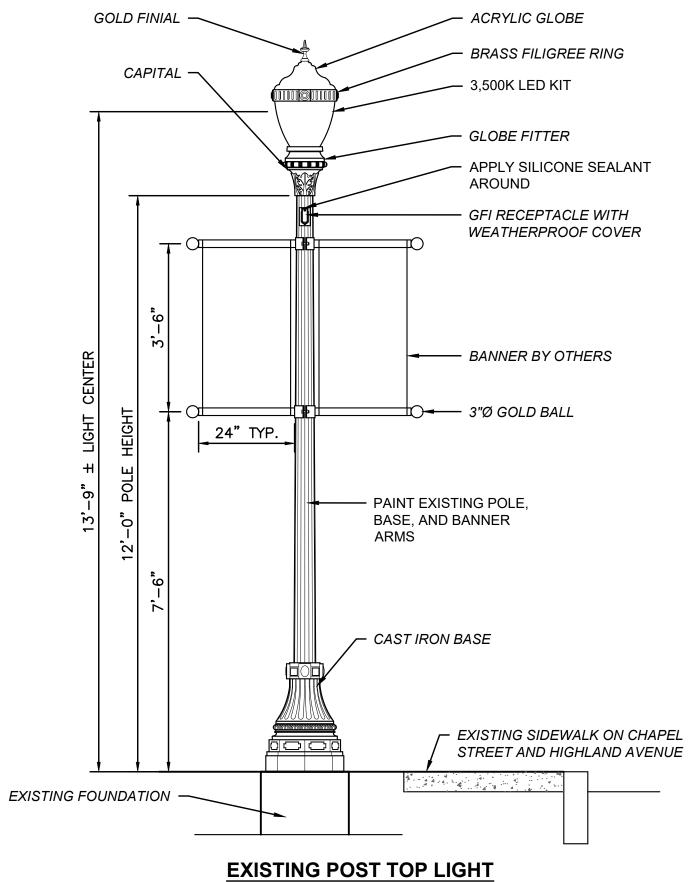

SCALE: $\frac{1}{2}$ "=1'-0"

DRAWN BY: SR/NS/CC DESIGNED BY: CHECKED BY: SR/RM DATE MADE BY CHECKED BY REVISIONS

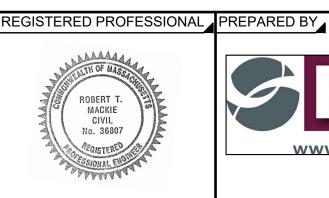



SCALE **AS SHOWN** NLESS OTHERWISE NOTED OR CHANGED BY REPRODUCTION

TOWN COMMON RENOVATION ELECTRICAL DETAILS NEEDHAM, MASSACHUSETTS

7185 BETA JOB NO. . NOV. 4, 2021 ISSUE DATE ___ SHEET NO.

TURNBUCKLE &
THREAD (828-9600-02)

6MM 316 WIRE

LOOP SWAG WITH
THIMBLE (804-0600)

SHACKLE BOLT (835-08-1)

EYE BOLT (837-0800)


DRILL HOLE TO
RECEIVE EYE BOLT
NUT & WASHER

STEEL BEAM

SINGLE POLE MOUNT


DUAL POLE MOUNT (LOCATION 1)

MOUNTING TAB LOCATION SCALE: 3" = 1'

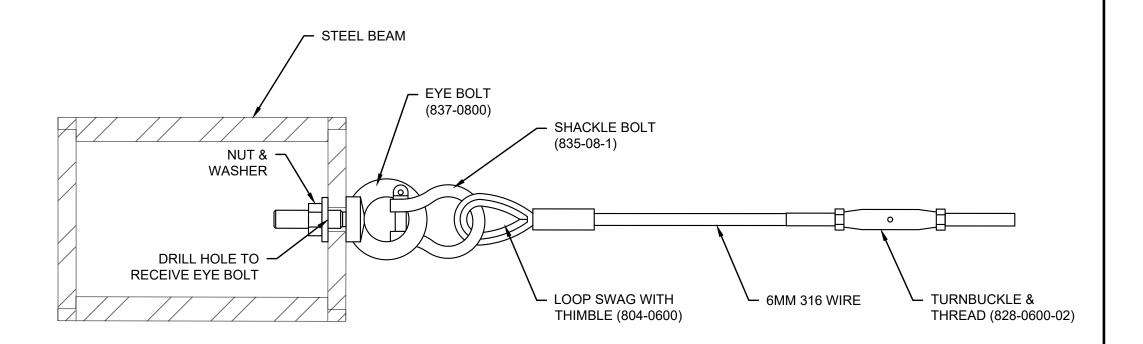

CABLE MOUNTING TAB SCALE: 6" = 1'

					DRAWN BY:
					SR/NS/CC
					DECICNED BY:
					DESIGNED BY:
					SR/NS
					CHECKED BY:
					SR/RM
NUMBER	DATE	MADE BY	CHECKED BY	REVISIONS	

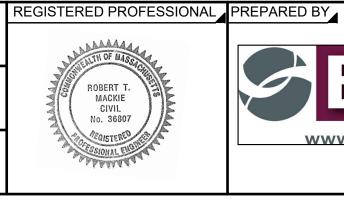



SCALE		
	AS SHOWN	

JNLESS OTHERWISE NOTED OR CHANGED BY REPRODUCTION

TOWN COMMON RENOVATION


DETAILS


NEEDHAM, MASSACHUSETTS

BETA JOB NO. 7185

ISSUE DATE NOV. 4, 2021

SHEET NO. 17

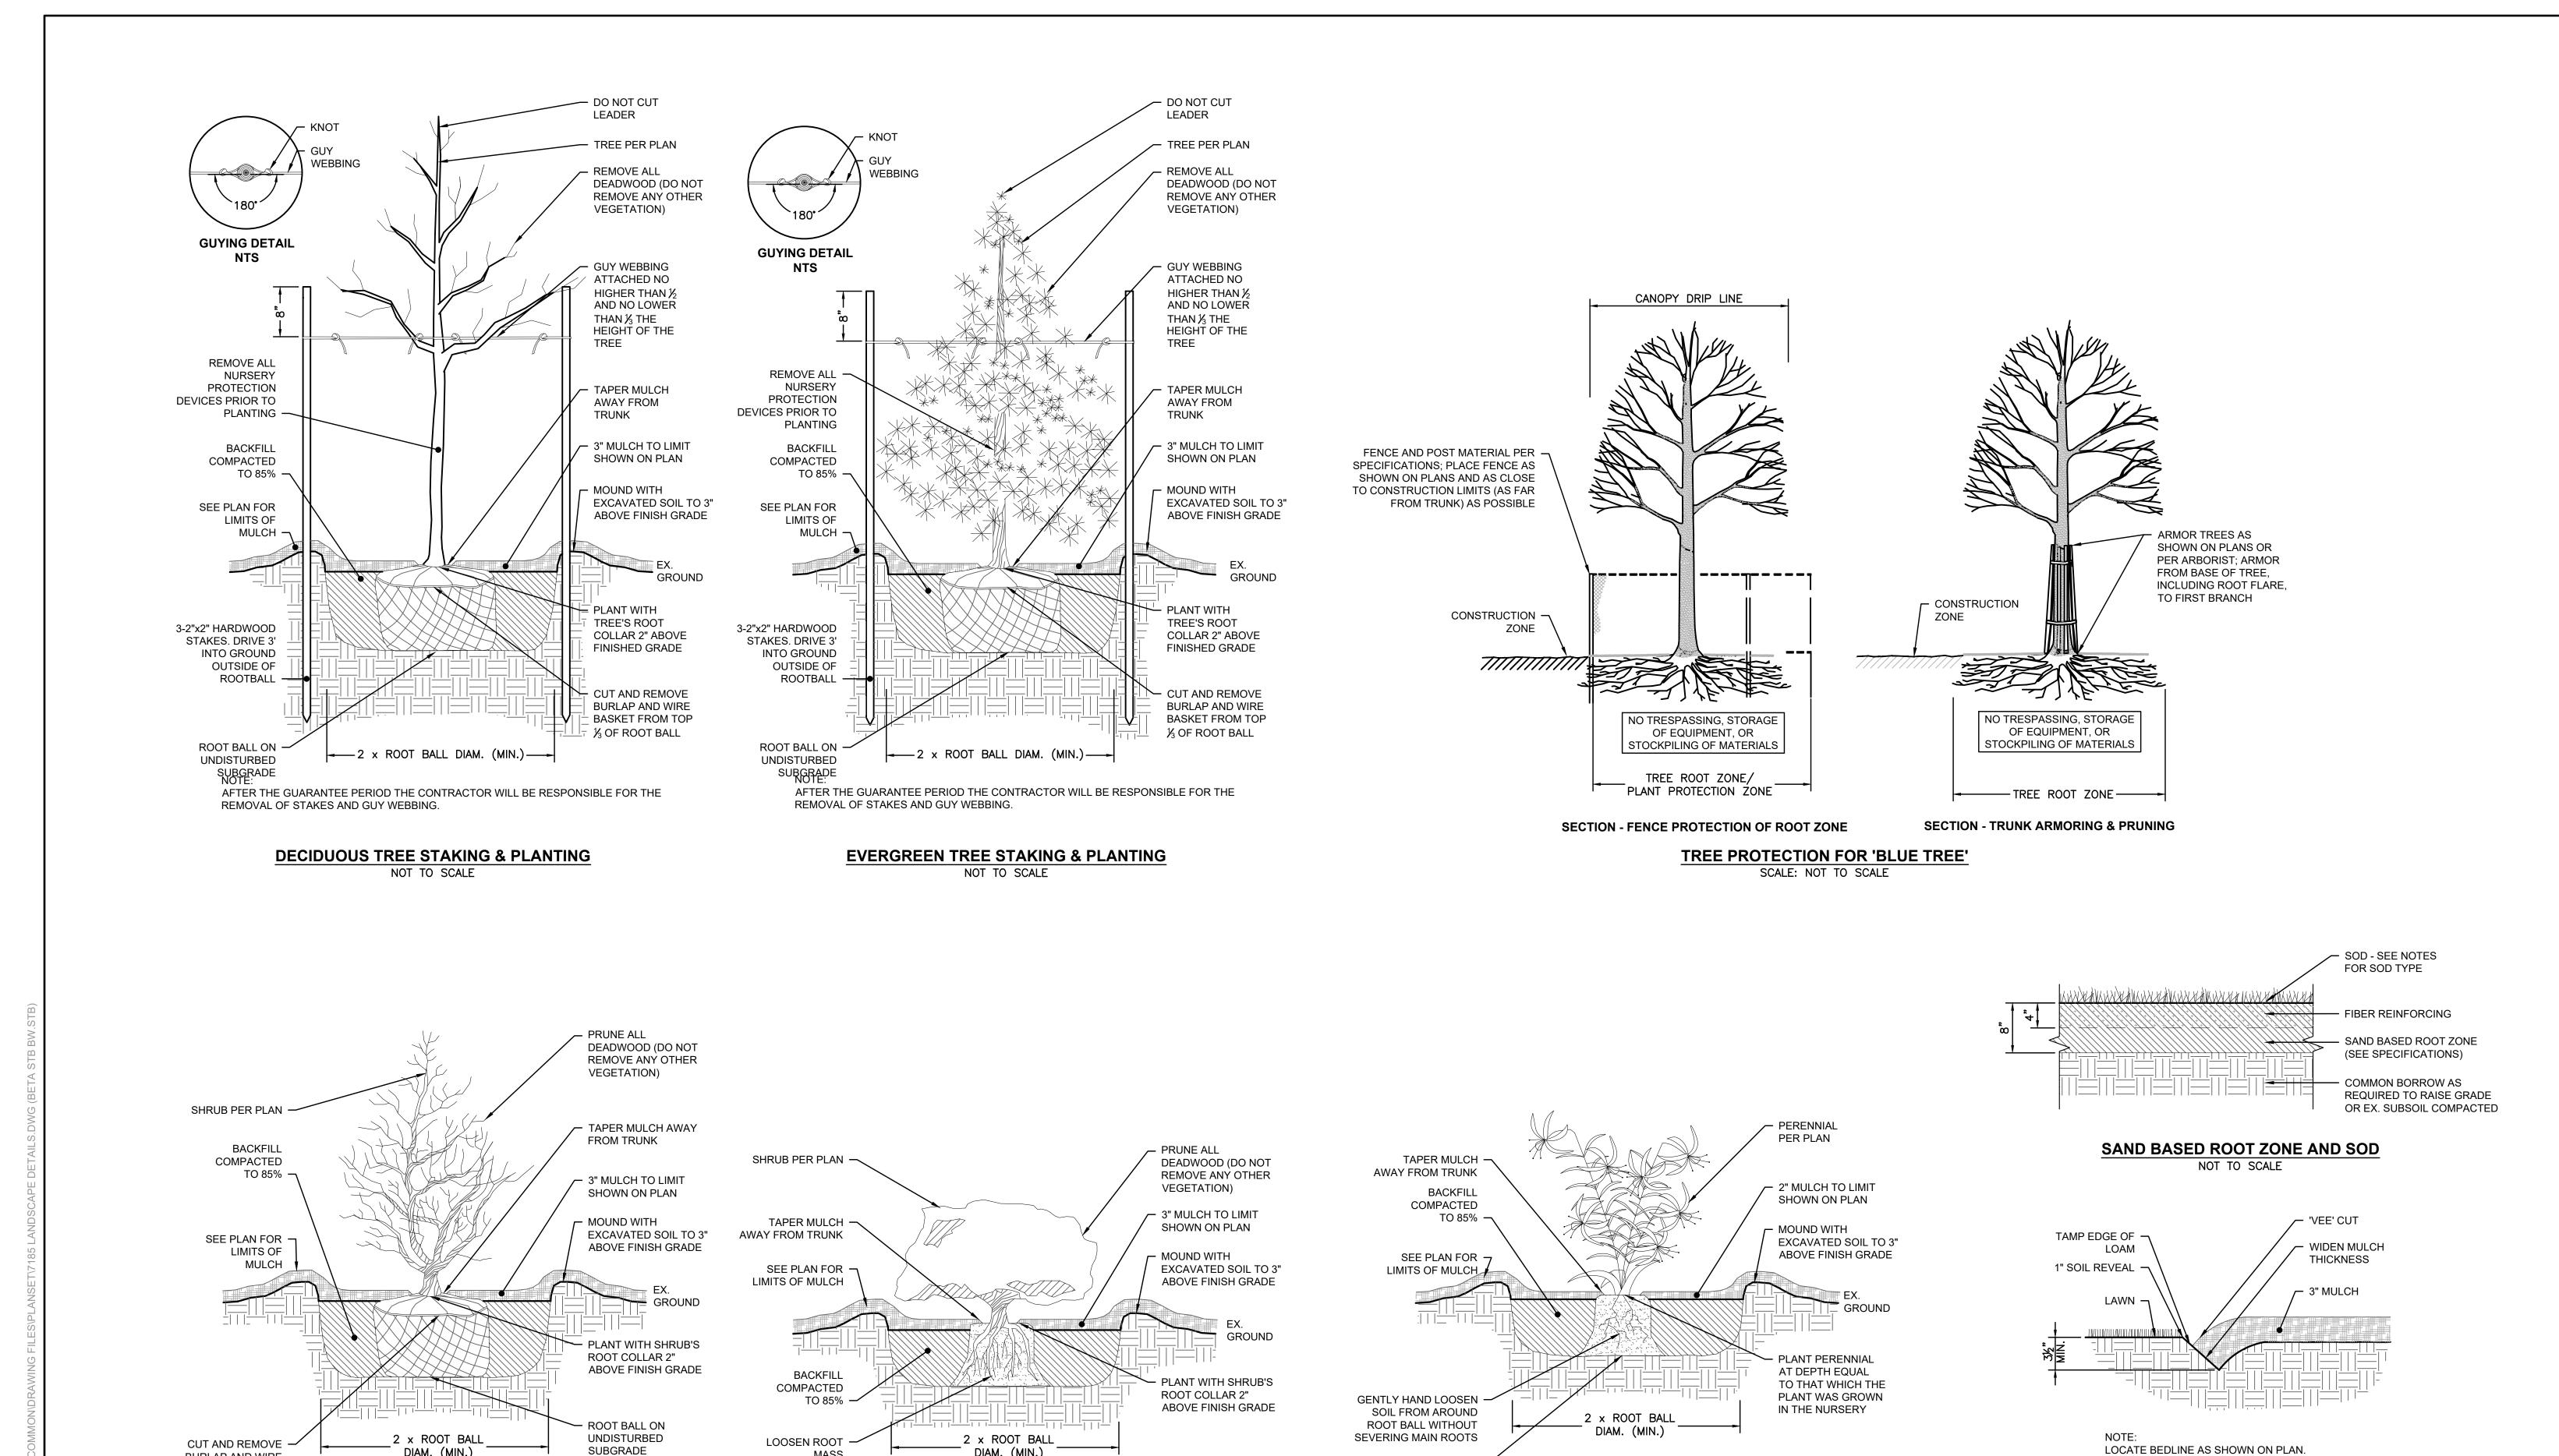

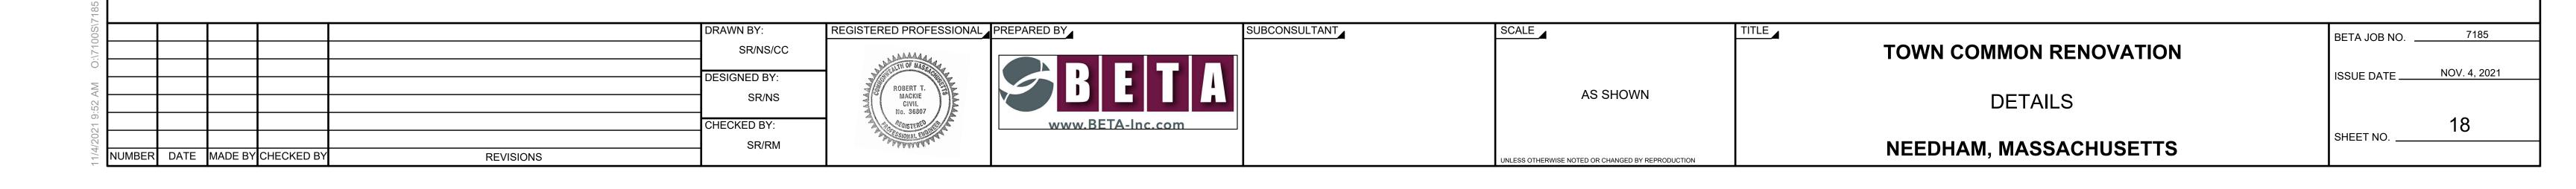

SPREAD ROOTS OVER

UNDISTURBED

SUBGRADE PERENNIALS & GRASSES PLANTING

NOT TO SCALE

BEDLINE EDGE

NOT TO SCALE

DIAM. (MIN.)

CONTAINER GROWN TREE & SHRUB PLANTING

NOT TO SCALE

SUBGRADE

DIAM. (MIN.)

SHRUB PLANTING

NOT TO SCALE

BURLAP AND WIRE

BASKET FROM TOP 1/3

OF ROOT BALL. FOLD UNDER, SO AS NOT TO

EXPOSE ABOVE GRADE